



National Aeronautics and " Space Administration

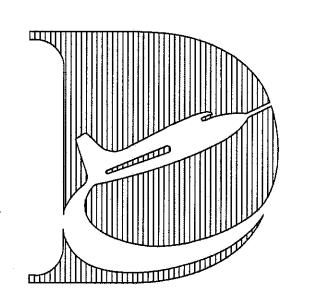



DRYDEN FLIGHT RESEARCH CENTER

PROJECT TITLE:

REPAIR PRIMARY ELECTRICAL DISTRIBUTION SYSTEM, PHASE VI OPTION #2 - SUBSTATION 11 - 100%

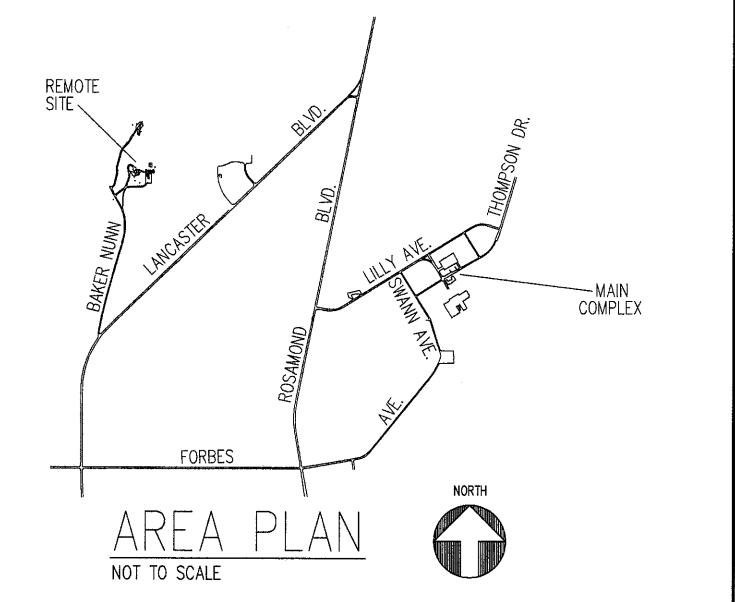

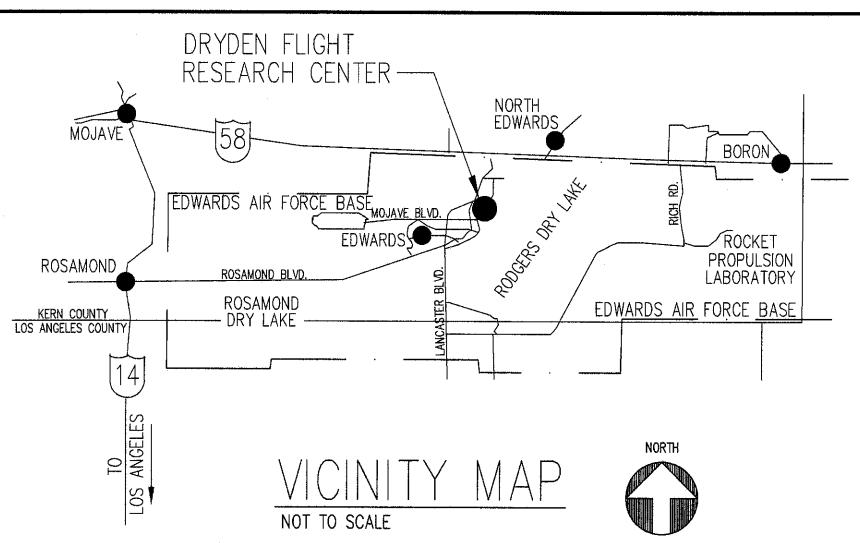

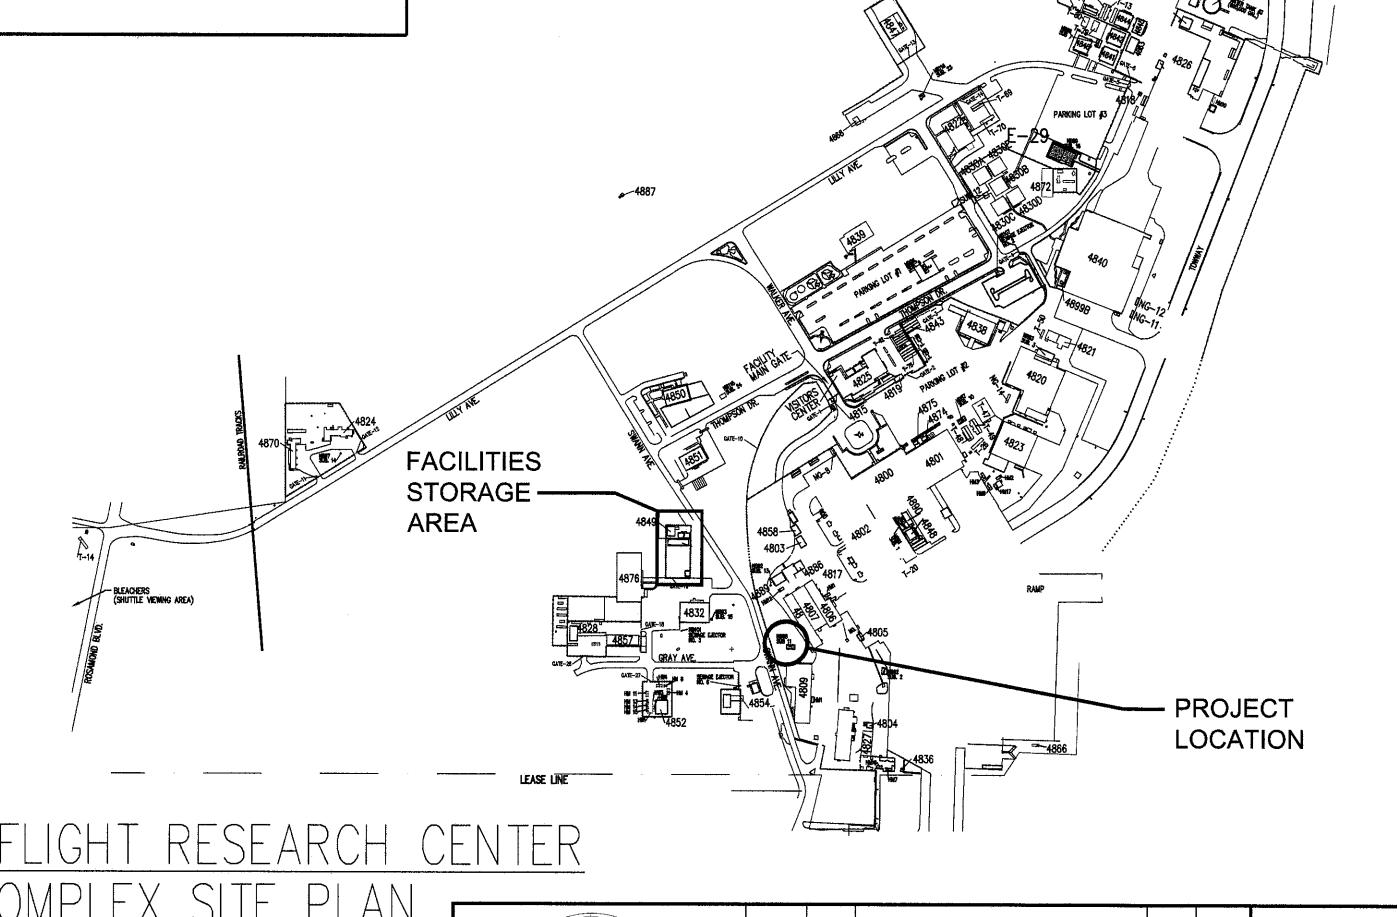



TITLE AND INDEX SHEET T2 GENERAL NOTES C1 | INDEX, LEGEND & ABBREVIATIONS C2 CIVIL SITE PLAN C3 DETAILS C4 DETAILS E1 ELECT. SYMBOLS, NOTES AND ABBREVIATIONS E2 SINGLE LINE DIAGRAM E3 UTILITY PLAN E4 PARTIAL SITE PLAN DEMOLITION E5 PARTIAL SITE PLAN REMODEL E6 ELECTRICAL DETAILS

DRAWING INDEX

THIS PACKAGE IS BID OPTION #2 FOR PROJECT EDM-1698 - REPAIR PRIMARY ELECTRICAL DISTRIBUTION SYSTEM PHASE VI AND IS INTENDED TO BE EXECUTED UNDER THE SAME SPECIFICATIONS, GENERAL CONDITIONS AND REQUIREMENTS OF THAT PROJECT AS REQUIRED BY THE NASA CONTRACTING OFFICER.

SCOPE: REPLACE EXISTING ELECTRICAL EQUIPMENT, AND INSTALL NEW ELECTRICAL EQUIPMENT AT DFRC SUBSTATION #11. DEMOLISH EXISTING FENCE AND PARTIAL CONCRETE PAD. INSTALL NEW CONCRETE YARD, RAISED EQUIPMENT PAD AND FENCE WITH GATES.

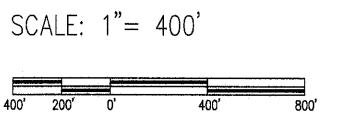

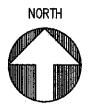



C23740
Signature 2
10/31/11 Renewal Date
OF CALLORING
DEVELOPMENT ONE, INC.
1611 East Fourth Street, Suite 250 Santa Ana, California 92701
J.Bruce Camino, Architect, AIA, NCARB (714) 689-0298
(714) 648-0197 FAX

DATE SYM

REVISION

	NATIONAL AERONAUTICS AND SPACE A
	DRYDEN FLIGHT RESEARCH EDWARDS, CA
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PROJECT


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EDWARDS, CA	Project Manager	Hack	
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TITLE	June		
REPAIR PRIMARY ELECTRICAL	DRAWN BY	DRM)	DATE S
	₩.O. #	770.05	DATE P
DISTRIBUTION SYSTEM, PHASE VI	PLOT SCALE	TRADE SH. No.	l Fr
$(OP \hat{I} ION) \# 2 - SUBSTATION 11 - 1003$	CAD FILE NAM	E 74	

ABBREVIATIONS ACT ACOUSTIC TILE ACP ACCESS PANEL ACT ASBESTOS COMPOSITION TILE ABOVE FINISH FLOOR ALUM ALUMINUM BD BOARD BLDG CPT BUILDING CARPET CEM CEMENT CH CEILING HEIGHT CEILING CLR CLEAR CMU CONCRETE MASONRY UNIT CONC CONTRACTOR PROVIDED OWNER INSTALLED CT CERAMIC TILE DWP DRYWALL PAINTED DR DOOR **EXISTING** ELASTOMERIC MEMBRANE ΕN ENAMEL ELECTRIC WATER COOLER **EWC EXIST EXPOSED CONSTRUCTION** EC EXPOSED CONSTRUCTION PAINTED ECP **EXTR** EXT FBI FEDERAL BUREAU OF INVESTIGATION FINISH CEILING FLOOR DRAIN FINISHED FLOOR FIN FINISH(ED) FIRE EXTINGUISHER CABINET FOW FACE OF WALL GALV GALVANIZED GLASS **GWB** GYPSUM WALL BOARD GYP GYPSUM HOLLOW CORE HARDWARE НМ HOLLOW METAL HR HOUR **HEIGHT** HWD HARDWOOD INS INSULATION INT INTERIOR LAMINATE MFR MANUFACTURER MFT MINERAL FISSURED TILE MIN MINIMUM MWP MEMBRANE WATERPROOFING NATURAL NEW NOT IN CONTRACT ОН OVERHANG OPCI OWNER PROVIDED, CONTRACTOR INSTALLED OWNER PROVIDED. OWNER INSTALLED PERFORATED PERF PLASTER PLASTIC LAMINATE PANEL PAINT **PARTITION** PLYWOOD QUARRY TILE RUBBER BASE REFER TO REINFORCING SOLID CORE SIMILAR STAINLESS STEEL SEE STRUCTURAL DRAWINGS STRUCTURAL STRUCT SUSPENDED TO BE DETERMINED TBD TELEPHONE TEL THRESHOLD THLD TOP OF SLAB TOS UNIFORM BUILDING CODE UNDERGROUND UTILITY UG TYP TYPICAL UNDER CUT UC UNLESS OTHERWISE NOTED VINYL COMPOSITION TILE VERIFY IN FIELD VWC VINYL WALL COVERING VYN VINYL WALL CLEAN OUT WD WOOD WEATHER PROOF WP WATER RESISTANT WR WOVEN WIRE FABRIC

SYMBOL LEGEND

EXTERIOR ELEVATION AND PHOTO REFERENCES

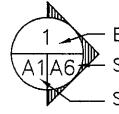

- BLDG. ELEV. NUMBER

A1A6 SHEET ON WHICH DETAIL IS SHOWN

SHEET FROM WHICH ELEVATION IS TAKEN

SYMBOL LEGEND




DOOR MARKER

ROOM REFERENCE

ROOM ROOM NAME


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DETAIL REFERENCE

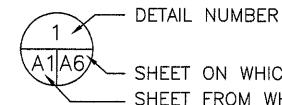

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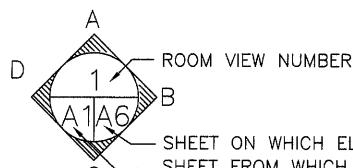
BUILDING SECTION



BUILDING SECTION NUMBER

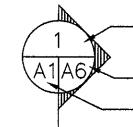- SHEET ON WHICH SECTION IS SHOWN -SHEET FROM WHICH SECTION IS TAKEN

INTERIOR ELEVATION REFERENCE



SHEET ON WHICH ELEVATION IS SHOWN - SHEET FROM WHICH ELEVATION IS TAKEN

GENERAL NOTES

- 1. ALL WORK SHALL BE PERFORMED IN ACCORDANCE WITH ALL APPLICABLE CODES, REGULATIONS AND ORDINANCES HAVING JURISDICTION.
- 2. INSTALL ALL MANUFACTURED ITEMS, MATERIALS AND EQUIPMENT IN STRICT ACCORDANCE WITH THE MANUFACTURER'S SPECIFICATIONS.
- 3. CONTRACTOR IS RESPONSIBLE FOR EXAMINING ALL CONTRACT DOCUMENTS, FIELD CONDITIONS AND CONFIRMING THAT WORK MAY BE CONSTRUCTED AS SHOWN BEFORE PROCEEDING WITH CONSTRUCTION. IF THERE ARE ANY QUESTIONS REGARDING THESE OR OTHER COORDINATION QUESTIONS, THE CONTRACTOR IS RESPONSIBLE FOR OBTAINING A CLARIFICATION FROM THE CONTRACTING OFFICER BEFORE PROCEEDING WITH WORK IN QUESTION.
- 4. ALL WORK NOTED "N.I.C." OR "NOT IN CONTRACT" IS TO BE ACCOMPLISHED BY A CONTRACTOR OTHER THAN THE GENERAL CONTRACTOR AND IS NOT TO BE PART OF THE CONSTRUCTION AGREEMENT. THE GENERAL CONTRACTOR SHALL COORDINATE WITH OTHER CONTRACTORS AS REQUIRED.
- "TYPICAL" AS USED IN THESE DOCUMENTS SHALL MEAN THAT THE CONDITION IS THE SAME OR REPRESENTATIVE FOR ALL SIMILAR CONDITIONS THROUGHOUT, UNLESS OTHERWISE NOTED.

GENERAL NOTES (CONT.)

- CONTRACTOR IS TO ERECT AND MAINTAIN TEMPORARY BRACING, BARRICADES, SIGNS, AND OTHER MEASURES AS NECESSARY TO PROTECT THE PUBLIC, WORKERS, OTHER PERSONS, AND ADJOINING PROPERTY FROM DAMAGE FROM DEMOLITION WORK, ALL IN ACCORDANCE WITH THE APPLICABLE CODES AND REGULATIONS. CONTRACTOR IS TO PROVIDE NOISE AND DUST ABATEMENT AS REQUIRED TO PREVENT DISTURBANCE AND NUISANCE TO ADJACENT PREMISES AND SURROUNDING AREAS. OPERATIONAL PROCEDURES SHALL BE OPTIONAL WITH THE CONTRACTOR DEMOLITION AND REMOVAL WORK SHALL BE DONE IN A MANNER WHICH WILL MINIMIZE THE SPREAD OF DUST AND FLYING PARTICLES. REMOVED MATERIALS AND DEBRIS SHALL BECOME THE PROPERTY OF THE CONTRACTOR AND SHALL BE DISPOSED OF OFF BASE IN A LEGAL
- 7. CONTRACTOR SHALL VERIFY ALL CONDITIONS AND DIMENSIONS AT THE JOB SITE PRIOR TO BIDDING AND START OF CONSTRUCTION. IF ANY DISCREPANCIES ARE FOUND, CONTRACTING OFFICER SHALL BE NOTIFIED FOR CLARIFICATION.
- 8. THE CONTRACTOR IS RESPONSIBLE TO VERIFY ALL EXISTING CONDITIONS AND DIMENSIONS SHOWN ON THE CONSTRUCTION DOCUMENTS BEFORE MANUFACTURING AND/OR FABRICATION OF ALL WORK. ANY WORK PROVIDED AND INSTALLED IN CONFLICT WITH THE CONSTRUCTION DOCUMENTS SHALL BE CORRECTED BY EACH CONTRACTOR AT NO ADDITIONAL COST TO THE CONTRACTING AGENCY.
- 9. ALL SYMBOLS AND ABBREVIATIONS ARE CONSIDERED TO BE CONSTRUCTION STANDARDS. IF ANY CONTRACTOR HAS A QUESTION OR NEEDS CLARIFICATION, CONTRACTING AGENCY IS TO BE CONTACTED BEFORE WORK, MANUFACTURING AND/OR FABRICATION COMMENCES.
- 10. DO NOT SCALE DRAWINGS; WRITTEN DIMENSIONS TAKE PRECEDENCE. LARGE SCALE DETAILS GOVERN OVER SMALL SCALE DETAILS.
- 11. CONTRACTOR IS REQUIRED TO GET PERMITS FROM NASA SAFETY OFFICE AND PROVIDE CURRENT TRAINING CERTIFICATIONS PRIOR TO ENTERING ANY CONFINED SPACE, OR PERFORMING HOT WORK (WELDING, BRAZING, CUTTING, GRINDING) OR WORK WITH ANY HAZARDOUS MATERIALS.
- 12. WHEN NOTED "APPROVED EQUAL" IT SHALL BE UNDERSTOOD THAT A PROPRIETARY PRODUCT MAY BE SUBSTITUTED BY THE CONTRACTOR WITH AN EQUIVALENT PRODUCT ONLY AS APPROVED BY THE CONTRACTING
- 13. WHEN A PROPRIETARY PRODUCT IS NOTED, CONTRACTOR MAY SUBSTITUTE AN EQUIVALENT PRODUCT ONLY AS APPROVED BY THE CONTRACTING OFFICER.
- 14. THIS CONSTRUCTION OPTION PACKAGE IS A SUBPART OF THE NASA DFRC PROJECT "REPAIR PRIMARY ELECTRICAL DISTRIBUTION SYSTEM, PHASE VI" AND IS SUBJECT TO THE SPECIFICATIONS MANUAL ISSUED FOR THAT PROJECT.

PROJECT TEAM

ARCHITECTURAL

DEVELOPMENT ONE, INC. 1611 E. FOURTH STREET, SUITE 250 SANTA ANA, CA 92701 TELEPHONE: (714) 689-0298 ex. 91 FAX: (714) 648-0197 E-MAIL: architects@developmentone.net

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J.B. YOUNG & ASSOCIATES, LTD. 11440 RIVERSIDE DRIVE, SUITE M LAKESIDE, CA 92040 TELEPHONE: (619)448-9424 FAX: (619)448-4690

ELECTRICAL

DONN C. GILMORE & ASSOCIATES, INC. 4051 E. LA PALMA, SUITE A ANAHEIM, CA 92807 TELEPHONE: (714) 630-4291 FAX: (714) 630-4805

CONSTRUCTION OPTIONS

THE CONTRACTOR SHALL ISSUE A COMPLETE BID FOR THE ENTIRE PROJECT WITH THE FOLLOWING ITEMS IDENTIFIED WITH AS CONSTRUCTION BID OPTIONS:

1) BID OPTION #1: PARKING LOT LIGHTING. (UNDER SEPARATE COVER)

(2) BID OPTION #2: SUBSTATION 11 (THIS PACKAGE)

(3) BID OPTION #3: CABLE TESTING (UNDER SEPARATE COVER)

LEGEND



INDICATES BID OPTION ITEM OR DRAWING REVISION ITEM



INDICATES OPTION NUMBER

INCICATES REVISION NUMBER



(714) 648-0197 FAX

DEVELOPMENT ONE, INC. 1611 East Fourth Street, Suite 250 Santa Ana, California 92701 J.Bruce Camino, Architect, AIA, NCARB (714) 689-0298

DATE	SYM	REVISION	BY	A'F

NATIONAL AERONAUTICS AND SPACE ADMINISTRATION LNAVA DRYDEN FLIGHT RESEARCH CENTER EDWARDS, CA DRAWING TITLE GENERAL NOTES

DRAWN BY DRM DATE STRTD 7-12-08 DATE PRNTD 6-14-10 PLOT SCALE EDM-1698 CAD FILE NAME T2 | SHEET No. 2 of 12

APPROVALS


Chief Fdcilities Engineering & Agest Mgmt. Office


REPAIR PRIMARY ELECTRICAL DISTRIBUTION SYSTEM, PHASE VI 2 OPTION #2 - SUBSTATION 11 - 100%


EXISTING CONDITIONS LEGEND	ABBREVIATIONS	HORIZONTAL AND VERTICAL CONTROL	GENERAL NOTES	
HORIZONTAL/AERTICAL CONTROL LIGHT POLE POWER POLE TRAFTIC SIGNAL SIGN SIGN SIGN SIGN SERVER MANIOLE DAM MANHOLE DAM NILET COLOR DAM NILET COLOR DAM NILET COLOR DAM NILET COLOR POST INDICATOR VALVE FIRE HORDNIT DAM NILET COLOR POST INDICATOR VALVE FIRE PODENT TREE Y 1507 & SPOT GRADE E. 13822 INVERT ELEVATION PRESSURE REDUCING VALVE ASSY BACKFLOW PREVENTION ASSEMBLY PANTED STOP LINE CANOPY/PATIO STRUCTURE OR BUILDING AND NUMBER FENCE DIRT SURFACE DIRT SURFACE GUARDRAIL TREE LINE INDEX CONTOUR (5' INTERVALS) APPROXIMATE CONTOUR (1' INTERVALS) APPROXIMATE SERVER FORCEAUNI LINE FILECOMMUNICATIONS SANTARY SEWER FORCEAUNI LINE POTABLE WATER LINE USED EXCLUSIVELY FOR FIRE SUPPRESSION SYSTEMS AND FIRE HORANIS. ABANDONED FUEL	MH MANHOLE MFR MANUFACTURER JB YOUN 11440 F Lakesid (619)	MONUMENT #1: CONCRETE MONUMENT AT CORNER OF WALKER AVE AND THOMPSON DR NORTHERN \$28,183.086: 182* ELEVATION 2,282.15* MONUMENT #2: CONCRETE MONUMENT NEAR CORNER OF MCKAY AVE AND THOMPSON DR NORTHERN \$28,801.559* EASTERN 2,033.461.916* ELEVATION 2,280.77* MONUMENT #3: CONCRETE MONUMENT AT CORNER OF WALKER AVE AND LILLY AVE NORTHERN \$22,717.766* EASTERN 2,033.320.393* ELEVATION 2,305.56* NO AND	1) CONTRACTOR SHALL POTHOLE ALL EXISTING UTILITY PIPES THAT CROSS NEW CONC EQUIPMENT PAOL BEFORE CROPPED FOR PIPE / DUCT BANK ELEVATIONS AT EACH PIPE CROSSING. CONTRACTOR SHALL BETTY CONTRACTOR OFFICES OF ANY POSSIBLE CONFLICTS. ALL POTENTIAL CONFLICTS SHALL BE RESOLVED BEFORE THE CONTRACTOR IS ALLOW TO ORDER ANY CRIAL UTILITY MATERIALS. DRAWING TITLE INDEX, LEGEND, & ABBREVIATIONS PROJECT TITLE REPAR PRIMARY ELECTRICAL REPAR PROMARY ELECTRICAL REPAR PROMARY ELECTRICAL REPAR PROMARY ELECTRICAL REPARE UTILD REPARE UTILS REPARE UTILS REPARE PROMARY ELECTRICAL REPARE UTILS REPARE UTILS REPARE PROMARY ELECTRICAL REPARE UTILS REPARE UTILS REPARE UTILS REPARE UTILS REPARE PROMARY ELECTRICAL REPARE UTILS R	


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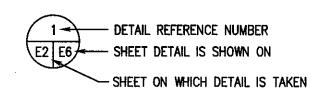




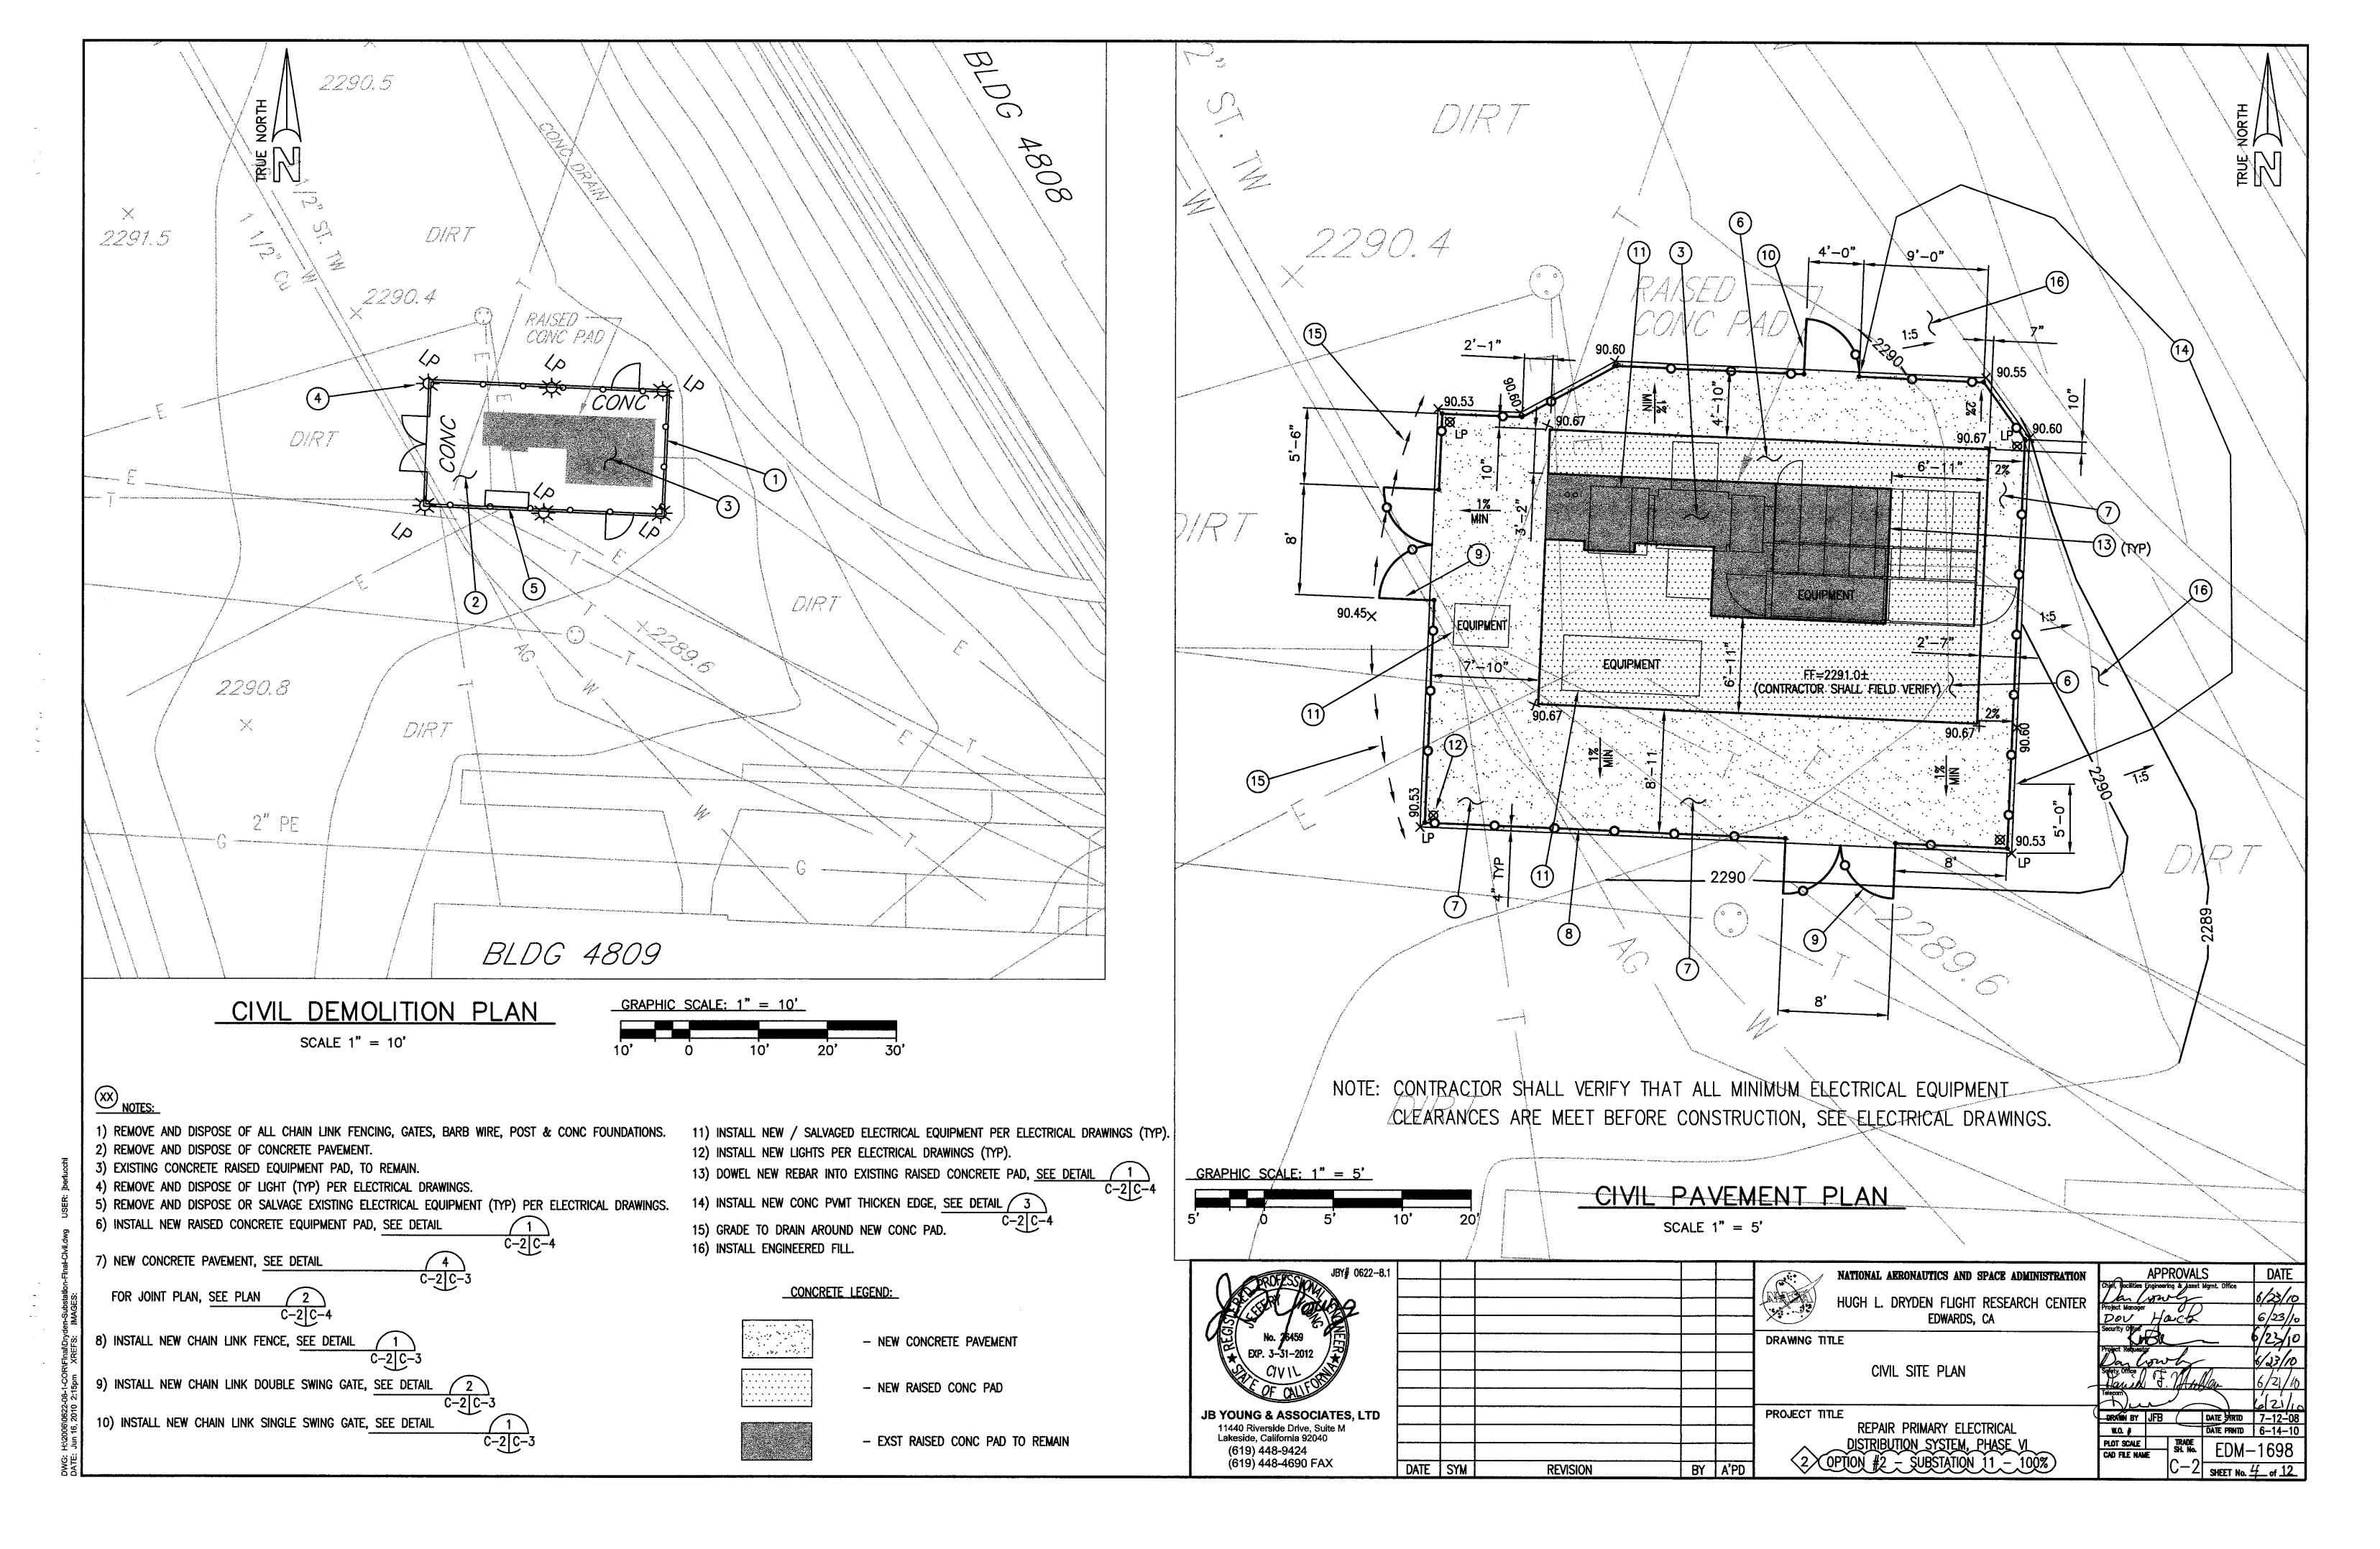

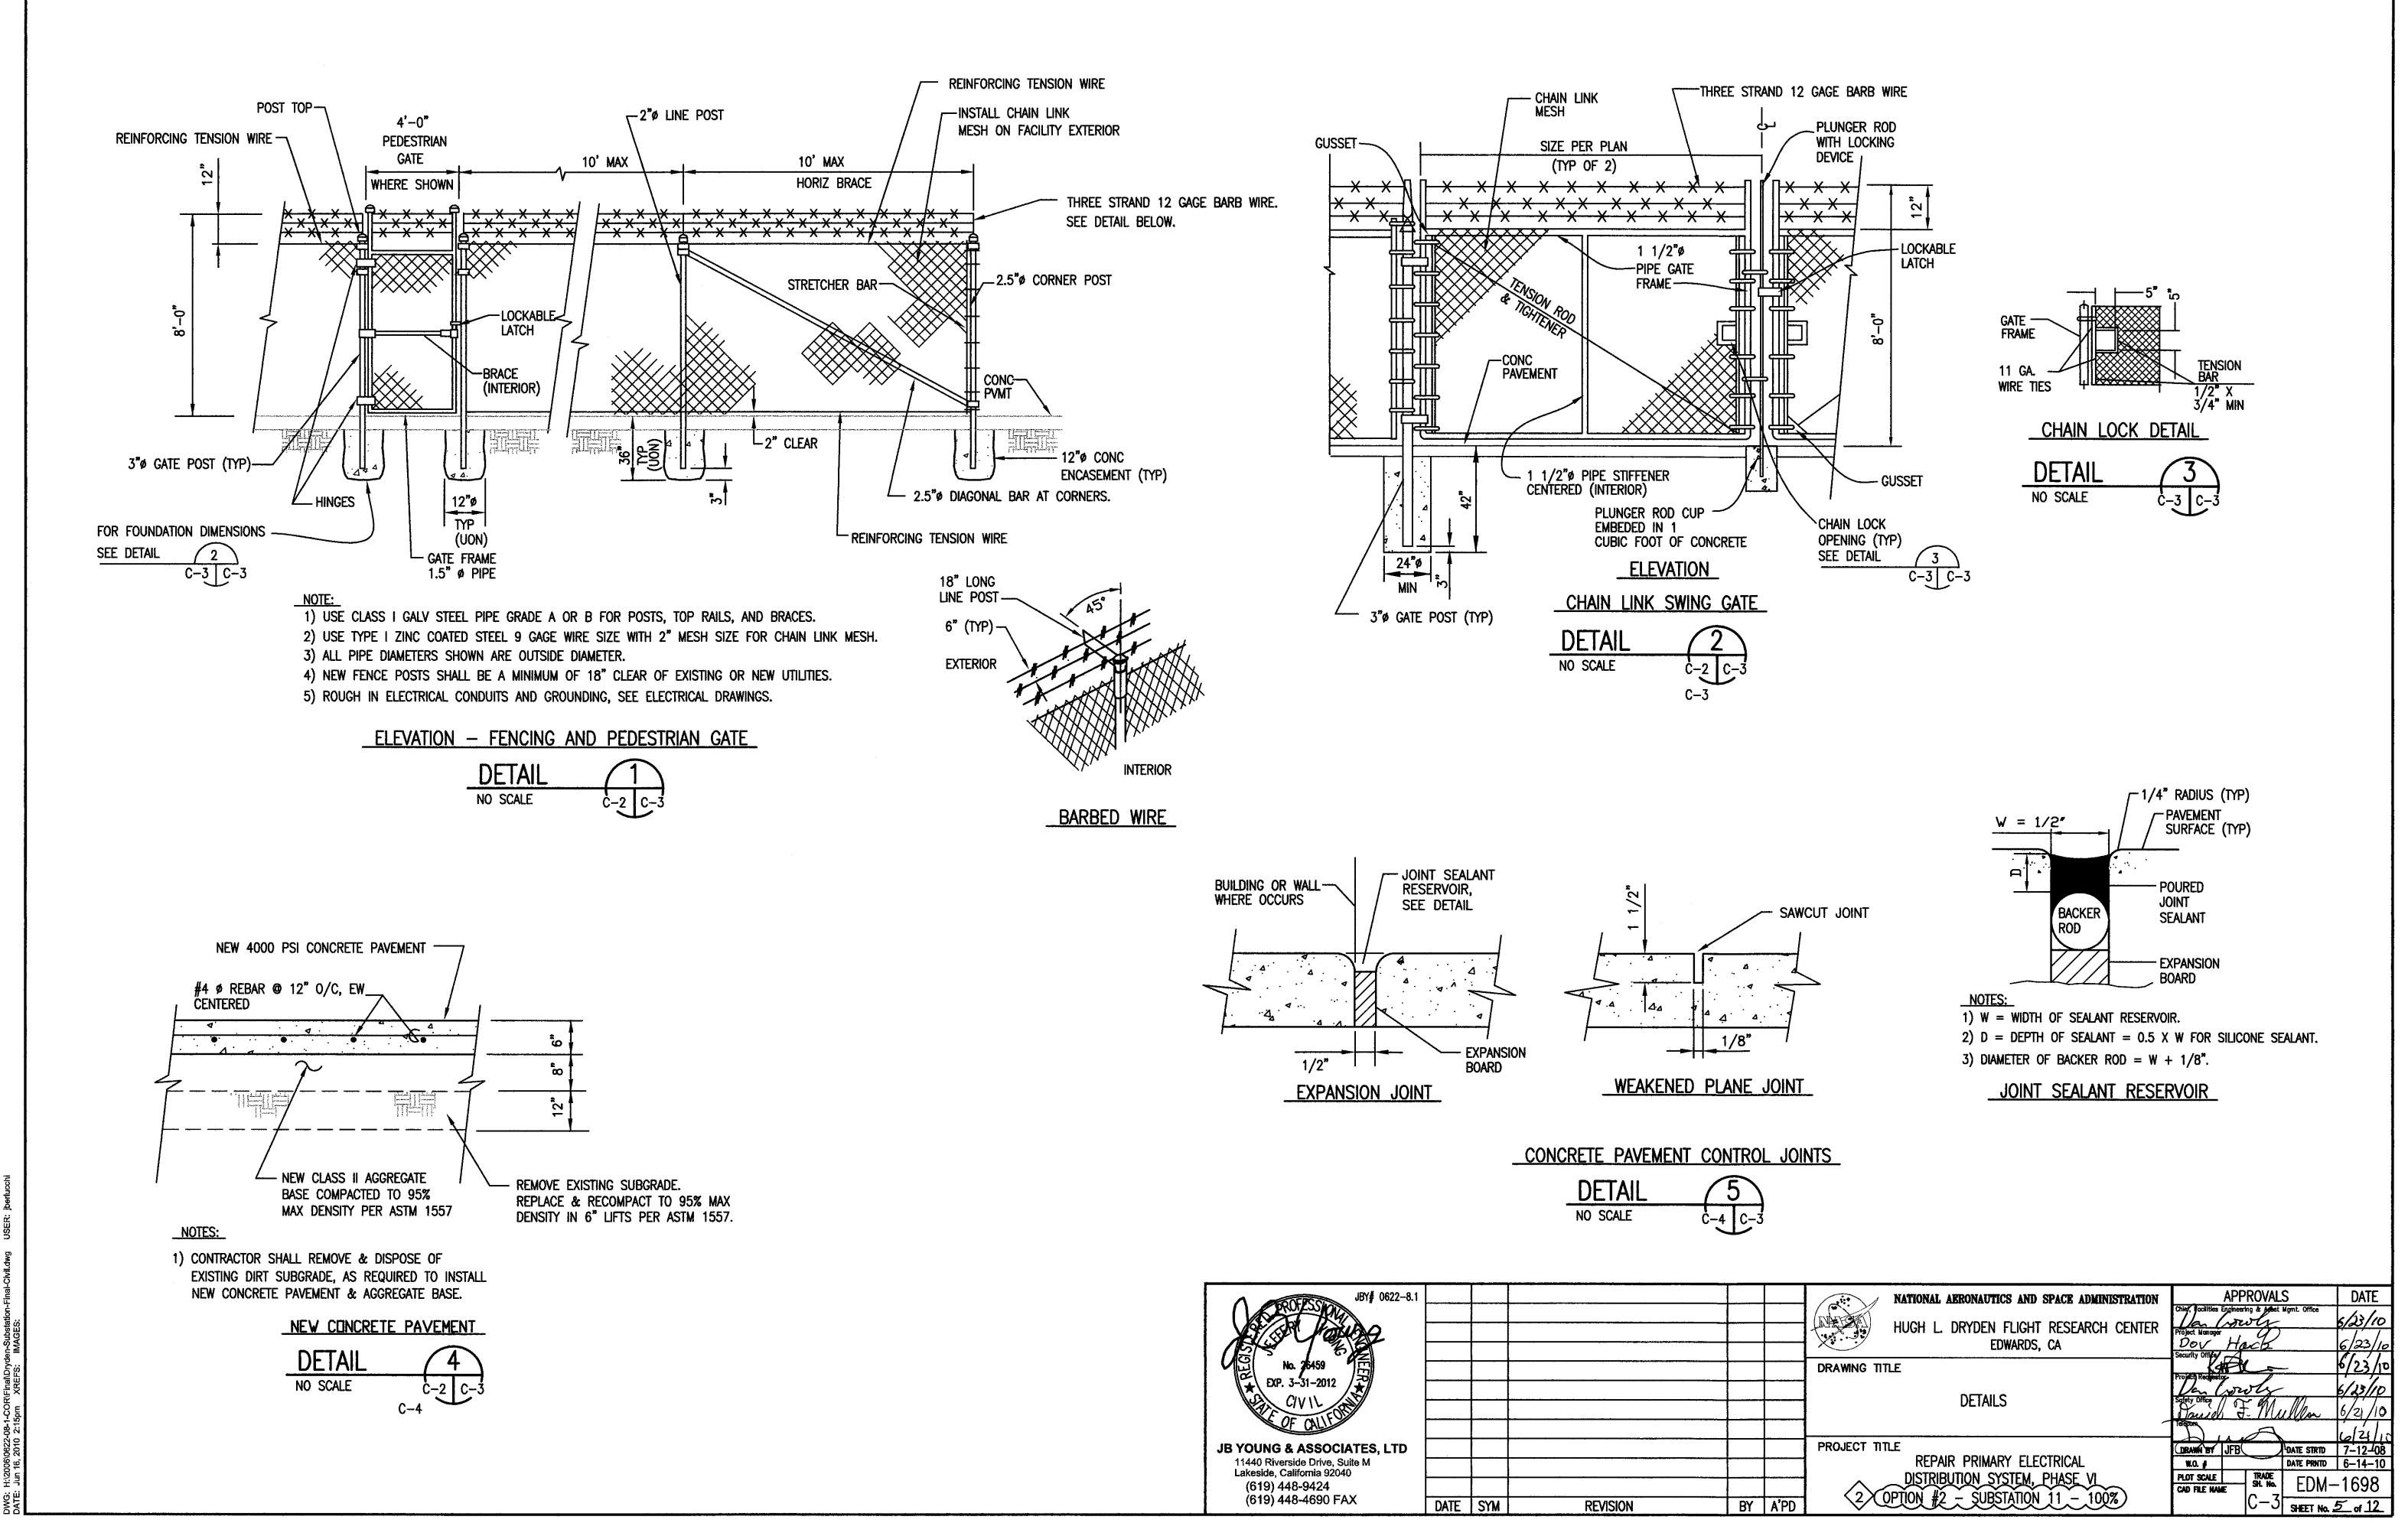JBY# 0622-8.1					<u> </u>	NATIONAL AERONAUTICS AND SPACE ADMINISTRATION	APPROVALS	DATE
				-		HUGH L. DRYDEN FLIGHT RESEARCH CENTER	Chief, Tacilities Engineering & Jesset Mgmt. Office	6/33/19
					 	EDWARDS, CA	Dou Hack Security Office	6/23/10
No. 26459 EXP. 3-31-2012					 	DRAWING TITLE	Project Regulator	5/2/10
EXP. 3-31-2012						DETAILS	Da Cowly	6/23/10
OF CALLED	ļ				<u> </u>	DETAILS	Daid & Mullen	6/21/10
JB YOUNG & ASSOCIATES, LTD						PROJECT TITLE		10/21/10
11440 Riverside Drive, Suite M Lakeside, California 92040						REPAIR PRIMARY ELECTRICAL	DRAWN BY JFB DATE STRID W.O. F DATE PRINTD	7-12-08 6-14-10
(619) 448-9424					 	DISTRIBUTION SYSTEM, PHASE VI	PLOT SCALE TRADE SH. No. EDM-	-1698
(619) 448-4690 FAX	DATE	SYM	REVISION	BY	A'PD	(2) OPTION $#2$ - SUBSTATION 11 - 100%	C-4 SHEET No.	€_ of 12

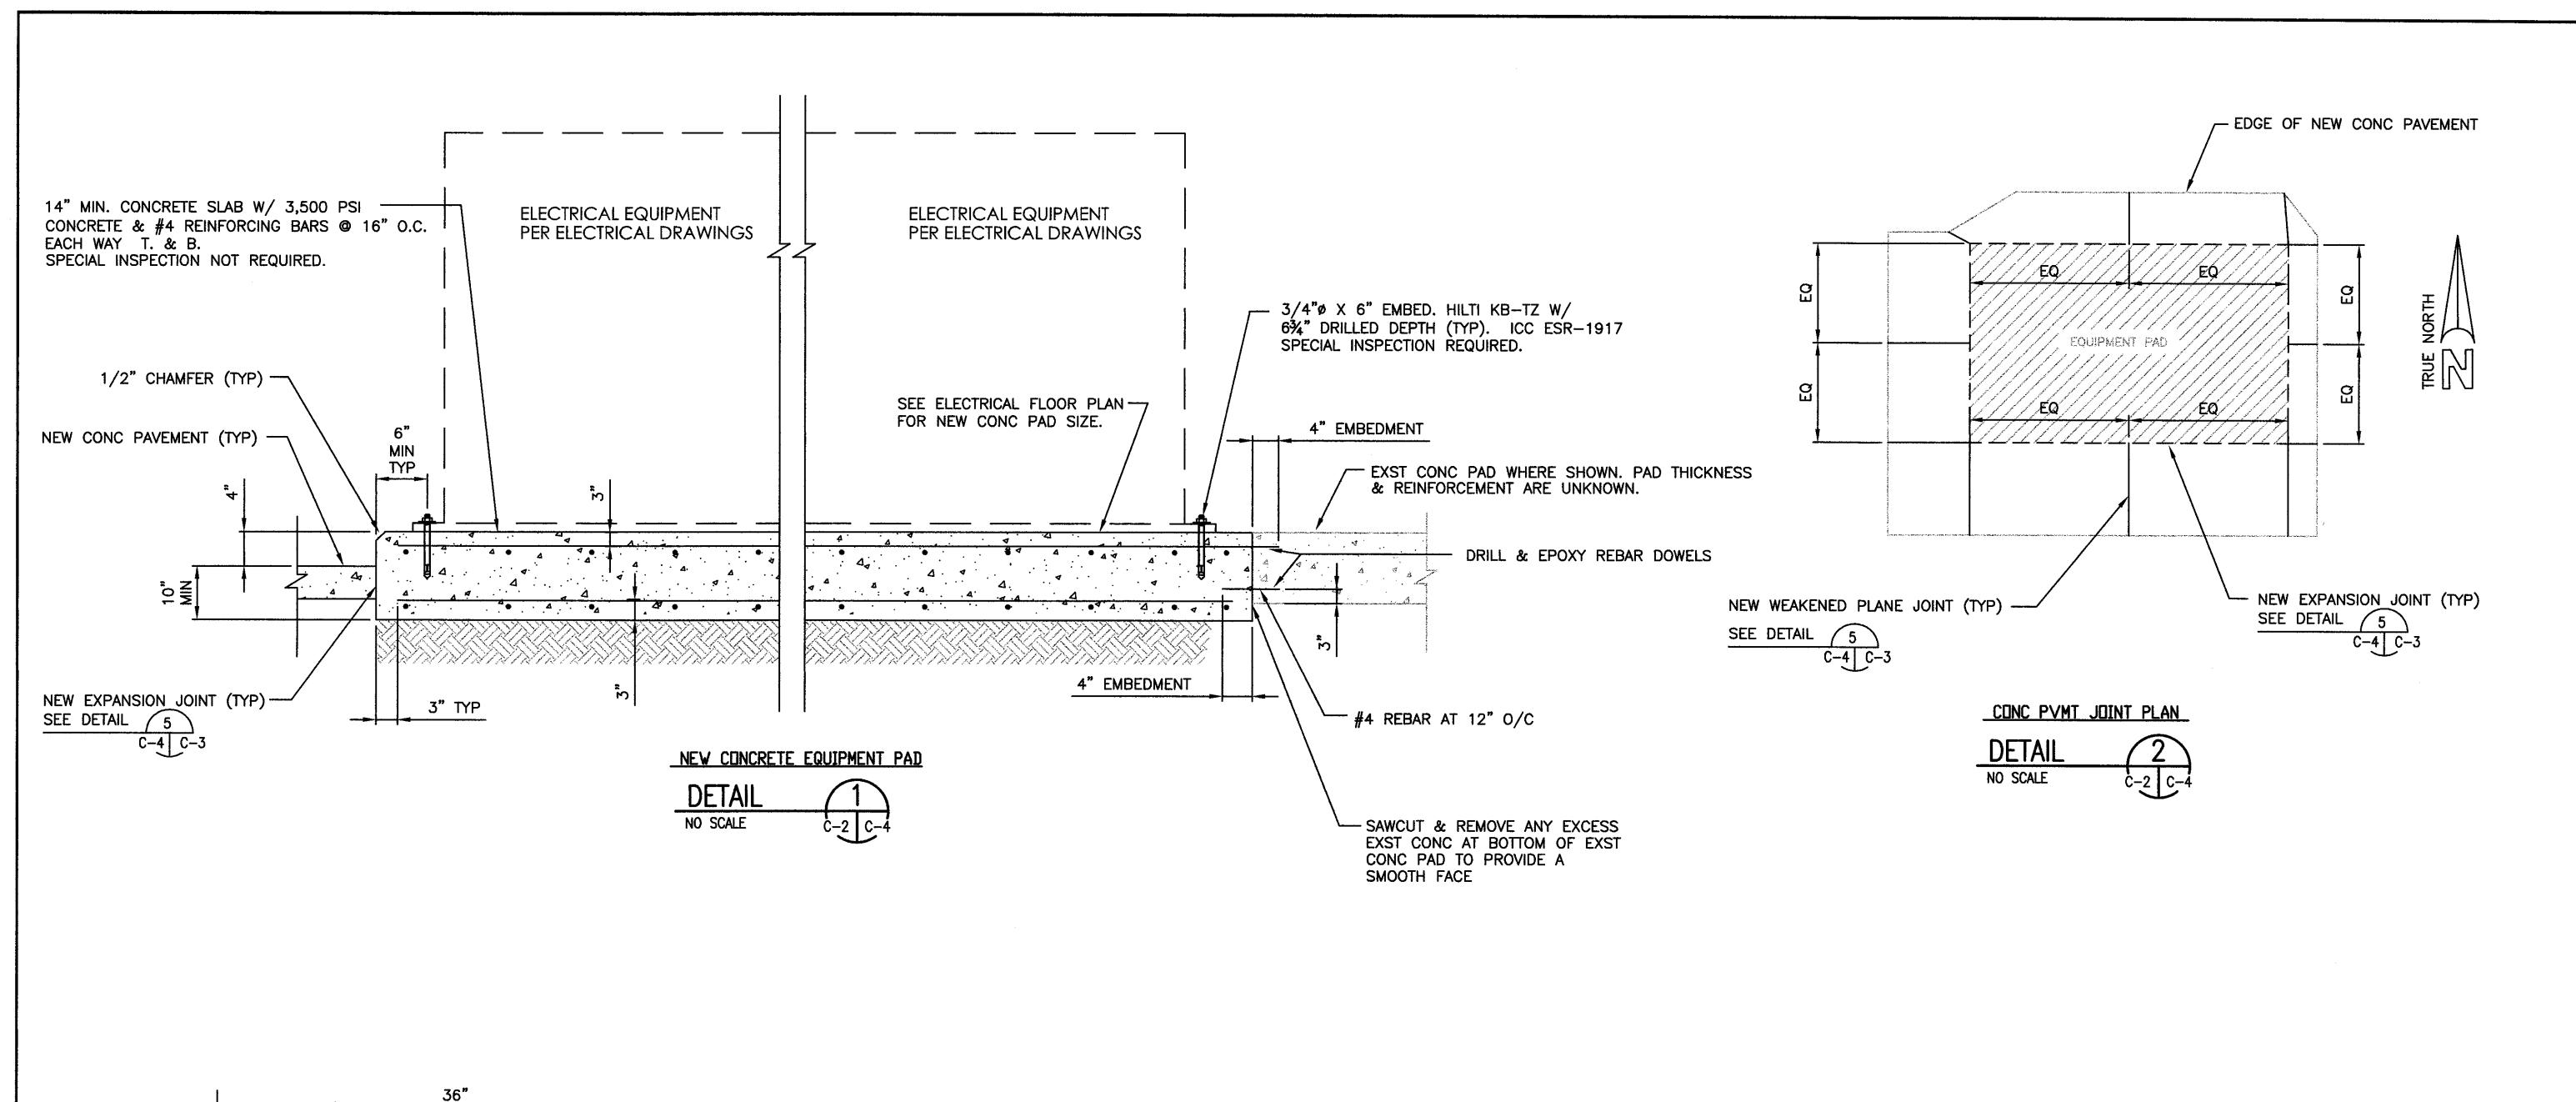ANNOTATIONS

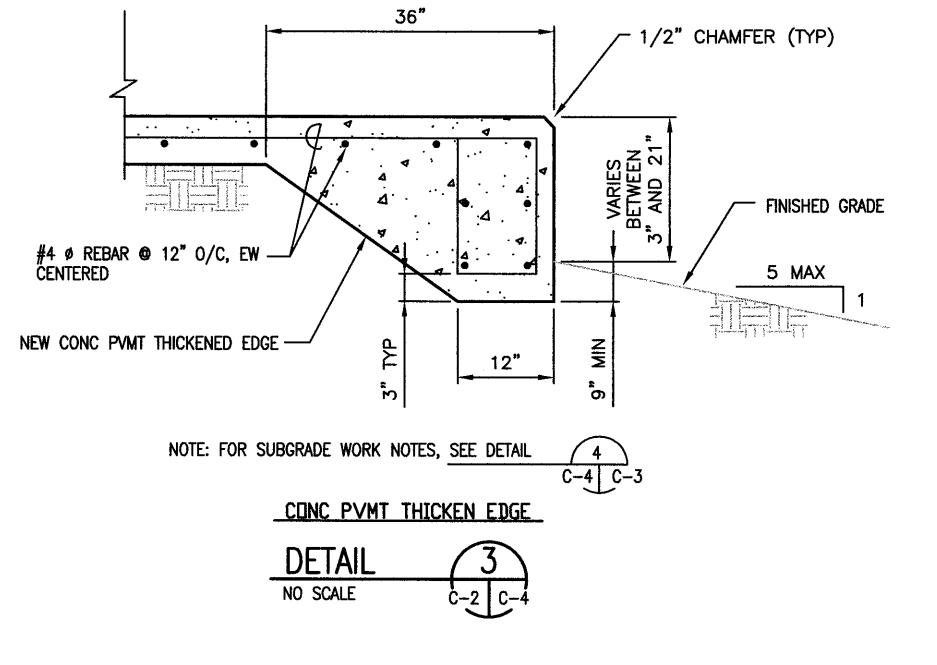



LIGHTING FIXTURE SCHEDULE), NUMBER ADJACENT INDICATES QUANTITIES (NUMBER IS SHOWN FOR BRANCH CIRCUIT PURPOSES ONLY, NOT FOR



PLAN NOTE REFERENCE, REFER TO NOTES ON SHEET, OR AS DIRECTED.

REVISION REFERENCE.

ABREVIATIONS ASPHALT CONCRETE AMERICAN WITH DISABILITIES ACT A.F.F. ABOVE FINISH FLOOR A.F.G. ABOVE FINISH GRADE AMERICAN WIRE GAUGE AMP, A AMPERE A.I.C. AMPERES INTERRUPTING CAPACITY (SYMMETRICAL) AF/AT AMP FRAME, AMP TRIP AS'/AF AMP SWITCH, AMP FUSE CIRC.,CKT. CIRCUIT BREAKER CONDUIT CM CENTIMETER C.O. CONDUIT ONLY, COMPLETE WITH PULLSTRING CONNECTED CPT CONTROL POWER TRANSFORMER CLCB CURRENT LIMITING CIRCUIT BREAKER CLF CURRENT LIMITING FUSE CURRENT TRANSFORMER DIA DIAMETER ELECTRICAL CONTRACTOR EMS ENERGY MANAGEMENT CONTROL SYSTEM EMT ELECTRICAL METALLIC TUBING ENT ELECTRICAL NON-METALLIC TUBING EWC ELECTRIC WATER COOLER E-0-L END-OF-LINE CIRCUIT TERMINATOR. EXHAUST FAN EQUIPMENT GROUND (GREEN) EXISTING EQUIPMENT EXPLOSION PROOF FIRE ALARM FACP FIRE ALARM CONTROL PANEL FACT FIRE ALARM TERMINAL CABINET FLA FULL LOAD AMPS GFCI GROUND FAULT CIRCUIT INTERRUPTER. GRD GROUND HAND-OFF-AUTO HEATING, VENTILATING AND AIR CONDITIONING H., W., D., L. HEIGHT, WIDTH, DEPTH, LENGTH HIGH INTENSITY DISCHARGE HORSEPOWER HIGH PRESSURE SODIUM HPS ISOLATED GROUND JBOX JUNCTION BOX DEGREE KELVIN KVA KILOVOLT AMPERES KILOWATT LONG CONTINUOUS LOAD LINEAR FEET LTG, LTS LIGHTING LOW PRESSURE SODIUM MAXIMUM MCB MAIN CIRCUIT BREAKER

MINIMUM

MILLIMETER

MAIN LUGS ONLY

MERCURY VAPOR

MOTOR CONTROL CENTER THOUSAND CIRCULAR MILS

MOTOR CIRCUIT PROTECTOR

NATIONAL ELECTRICAL CODE

OWNER FURNISHED, CONTRACTOR INSTALLED.

PRIMARY ELECTRICAL DISTRIBUTION CENTER

FURNISH, INSTALL AND CONNECT.

POTENTIAL TRANSFORMER

RIGID GALVANIZED STEEL

600 VOLTS AND LESS

TELEPHONE AND DATA

UNLESS OTHERWISE NOTED

METAL HALIDE

MANUFACTURER

NORMALLY CLOSED

NORMALLY OPENED

NOT IN CONTRACT

MOUNTED

MICROWAVE

NON-FUSED

NIGHT LIGHT

PHOTOCELL

PHASE

OVER 600 VOLTS

PUBLIC ADDRESS

RECEPTACLE

TIMECLOCK

TELEVISION

WEATHERPROOF

TYPICAL

VOLTS VOLT AMPERES

REFRIGERATOR

Number

MTD

NO. or #

OFCI

PEDC

PRIMARY

PH. or Φ

PROVIDE

PA

REC, RECEPT

RGS

SECONDARY

TEL/DATA

U.O.N.

LIGHTING FIXTURE CALL OUT, "3" INDICATES FIXTURE TYPE (REFER TO MATERIAL TAKE-OFF). NUMBER "93" INDICATES FIXTURE WATTS

> PENETRATION THROUGH STRUCTURAL MEMBERS OR FIRE RATED WALLS AND SLABS. 6. SHOULD PROJECT CONDITIONS REQUIRE REARRANGEMENT OF WORK, THE CONTRACTOR SHALL MARK SUCH CHANGES ON THE AS-BUILT DRAWINGS. IF THESE CHANGES REQUIRE ALTERNATE METHODS TO THOSE SPECIFIED IN THE CONTRACT DOCUMENTS, THE CONTRACTOR SHALL SUBMIT DRAWINGS SHOWING THE PROPOSED ALTERNATE METHODS TO THE CONTRACTING OFFICER. THE CONTRACTOR SHALL NOT PROCEED UNTIL APPROVAL IS OBTAINED. REARRANGEMENT OF WORK FOR THE PURPOSE OF COORDINATION SHALL NOT BE CONSIDERED AN ITEM FOR

CONDUIT SIZES CALLED OUT ON DRAWINGS ARE NOT NECESSARILY BASED ON THE MINIMUM SIZE ALLOWED BY

AVOID EXCESS CONDUIT HEATING. IN NO CASE SHALL CONDUIT SIZE BE SMALLER THAN IS REQUIRED BY THE

INSTALLATION OF ELECTRICAL DEVICES AND EQUIPMENT, WHETHER OR NOT SPECIFICALLY INDICATED ON THE

4. ALL PENETRATIONS THROUGH FIRE BARRIERS SHALL BE FIRE STOPPED TO MAINTAIN THE INTEGRITY OF THE FIRE

2. THE CONTRACTOR SHALL PROVIDE AND INSTALL ALL JUNCTION AND PULL BOXES REQUIRED FOR THE

THE CONTRACTOR SHALL FURNISH ALL EQUIPMENT FOR TEMPORARY CONSTRUCTION POWER AS REQUIRED.

5. THE CONTRACTOR SHALL OBTAIN APPROVAL FROM THE CONTRACTING OFFICER BEFORE DRILLING ANY

Plans. Size of these boxes shall be per the national electrical code.

BARRIER. FIRE STOPPING MATERIAL SHALL BE U.L. LISTED.

THE NATIONAL ELECTRICAL CODE AND MAY BE PURPOSELY OVERSIZED FOR EASE OF CONDUCTOR PULLING OR TO

GENERAL NOTES:

NATIONAL ELECTRICAL CODE.

7. THE CONTRACTOR SHALL SUBMIT SHOP DRAWINGS IN ACCORDANCE WITH THE CONTRACT DOCUMENTS. TESTING SHALL BE DONE IN ACCORDANCE WITH THE CONTRACT DOCUMENTS. SUBMIT A COPY OF SHOP DRAWINGS TO THE CONTRACTING OFFICER FOR INFORMATION.

8. PROVIDE ELECTRICAL SYSTEM EQUIPMENT TESTS AND RUNNING TESTS TO DEMONSTRATE ITS OPERATIONS AND COMPLIANCE WITH THE EQUIPMENT SPECIFICATIONS. TEST ALL WIRING AND EQUIPMENT TO INSURE PROPER OPERATION ACCORDING TO FUNCTIONS SPECIFIED HEREIN AND ON THE DRAWINGS. THE CONTRACTOR WILL SUBMIT DETAILED TESTING PLANS TO THE GOVERNMENT FOR REVIEW AND APPROVAL BEFORE TESTING CAN BEGIN. A PRETEST WILL BE PERFORMED BY THE CONTRACTOR AND ALL DISCREPANCIES MITIGATED BEFORE THE GOVERNMENT ACCEPTANCE TESTING WILL BEGIN. THE PRETEST WILL BE WITNESSED BY A GOVERNMENT REPRESENTATIVE. VERY LOW FREQUENCY TESTING, PER SECTION 337102, SHALL ONLY BE PERFORMED ON NEW MEDIUM VOLTAGE CABLES.

ALL WORK IN THIS SECTION SHALL BE UNDER WARRANTY FOR A PERIOD OF ONE YEAR FROM THE DATE OF ACCEPTANCE OF THE WORK AS A WHOLE BY THE CONTRACTING OFFICER. SHOULD ANY EQUIPMENT OR MATERIAL FAIL WITHIN THIS PERIOD, THE CONTRACTOR SHALL REPLACE OR REPAIR THAT ITEM AT NO COST FOR MATERIAL AND/OR SERVICES IF SUCH IS DUE TO FAULTY WORKMANSHIP OR QUALITY OF MATERIAL FURNISHED. THE CONTRACTOR SHALL BE RESPONSIBLE FOR ALL DAMAGE TO ANY PART OF THE PREMISES CAUSED BY FAILURE IN THE EQUIPMENT FURNISHED AS PART OF THE CONTRACT DRAWINGS FOR A PERIOD OF ONE YEAR AFTER THE FINAL ACCEPTANCE OF THE WORK AS A WHOLE.

10. ALL MECHANICAL CONTROL SYSTEMS EQUIPMENT SHALL BE PROVIDED, INSTALLED AND WIRED BY THE MECHANICAL CONTRACTOR PER THE CONTRACT DOCUMENTS. ELECTRICAL CONTRACTOR SHALL PROVIDE CONDUITS ONLY FOR ELECTRICAL POWER FOR THE MECHANICAL CONTROL SYSTEM EQUIPMENT SHALL BE PROVIDED BY THE ELECTRICAL CONTRACTOR. THIS INCLUDES THE POWER WIRING, AND CONNECTION TO THE MECHANICAL CONTROL SYSTEMS

11. ALL EQUIPMENT SHALL BE DESIGNED AND INSTALLED FOR USE IN A SEISMIC ZONE 4 AREA. ALL SEISMIC DESIGN SHALL BE STAMPED AND SIGNED BY A PROFESSIONAL STRUCTURAL ENGINEER LICENSED IN THE STATE OF

12. POTHOLE AND LOCATE ALL UTILITY LINES WITHIN THE PROJECT AREA PRIOR TO START OF EXCAVATION IN ORDER TO AVOID DAMAGE TO EXISTING UNDERGROUND UTILITIES. REPAIR ALL DAMAGES TO EXISTING UTILITIES AT NO

13. PATCH AND PAINT ALL EXPOSED ELECTRICAL MATERIAL, INCLUDING CONDUIT, SURFACE METAL RACEWAYS. JUNCTION BOXES, PANELS, AND DEVICES TO MATCH THE ADJACENT SURFACES IN TEXTURE AND COLOR.

BE PERFORMED TO MITIGATE THE RISK OF ACCIDENTAL EXPOSURE TO HIGH VOLTAGE

BY THE INTENT OF THE CONTRACT DOCUMENTS.

14. REPAIR ANY DAMAGE TO EXISTING CONSTRUCTION RESULTING FROM THE INSTALLATION OF ELECTRICAL ITEMS. THE AREAS REPAIRED SHALL MATCH THE ADJACENT SURFACES IN TEXTURE AND COLOR.

15. PROVIDE DEWATERING EFFORT FOR NEW BELOW GRADE EXCAVATION/TRENCHING IF GROUND WATER IS ENCOUNTERED. THE CONTRACTOR SHALL OBTAIN A DIGGING PERMIT BEFORE ANY EXCAVATION OR TRENCHING.

16. ALL ELECTRICAL SPLICES SHALL BE WATERPROOF. CONTRACTOR SHALL SUBMIT AN AHA ON HOW SPLICING IS TO

17. ALL MOUNTING HARDWARE, CHANNELS AND FASTENING DEVICES IN EXTERIOR LOCATIONS SHALL BE 316 STAINLESS STEEL UNLESS NOTED.

18. PROVIDE A COMPLETE AND OPERATING ELECTRICAL SYSTEM. PROVIDE SHALL MEAN "FURNISH AND INSTALL". WORK INCLUDES INSTALLATION OF ALL ELECTRICAL EQUIPMENT AND SYSTEMS, INCLUDING ANY FURNISHED BY OWNER OR OTHER TRADES, COMPLETE AND OPERATIONAL TO THE SATISFACTION OF THE CONTRACTING OFFICER, AS LIMITED

19. THE CONTRACTOR SHALL COMPLY WITH THE CONSTRUCTION PRACTICES AND REQUIREMENTS OF THE LATEST EDITION OF THE NATIONAL ELECTRIC CODE (NFPA 70), NATIONAL ELECTRICAL SAFETY CODE, AMERICAN ELECTRICIANS HANDBOOK BY CROFT EDISON ELECTRIC INSTITUTE, AMERICANS WITH DISABILITIES ACT, APPLICABLE INSTRUCTIONS OF MANUFACTURERS OF EQUIPMENT AND MATERIALS SUPPLIED FOR THE PROJECT, AND ALL ORDINANCES, RULES AND POLICIES OF THE STATE AND COUNTY IN WHICH THE WORK IS TO BE PERFORMED.

20. THE CONTRACTOR SHALL VISIT THE JOB SITE AND FAMILIARIZE HIMSELF WITH ALL EXISTING CONDITIONS AND THE EXTENT OF REMOVAL, RELOCATION, RECONNECTION AND/OR NEW WORK PRIOR TO BIDDING, BID SUBMISSION SHALL BE RESOLVED ALL DISCREPANCIES AND QUESTIONS AND NO EXTRA PAYMENT WILL BE AUTHORIZED FOR WORK MADE NECESSARY BY THE CONTRACTOR'S FAILURE TO DO SO.

21. ALL CIRCUITS SHALL INCLUDE AN INSULATED GREEN GROUNDING CONDUCTOR, SIZED PER THE NATIONAL ELECTRICAL CODE. THIS CONDUCTOR SHALL BE CARRIED IN ALL RACEWAYS INCLUDING THOSE INSTALLED FOR SWITCH LEGS AND SHALL BE ATTACHED TO THE DEVICE OR EQUIPMENT HOUSING USING A SUITABLE GROUNDING

22. AT COMPLETION OF CONSTRUCTION, CONTRACTOR SHALL PROVIDE A COPY OF AS-BUILT DRAWINGS IN CD-ROM TO THE CONTRACTING OFFICER.

23. SAWCUT EXISTING AC PAVEMENT/SIDEWALK FOR NEW UNDERGROUND DUCTLINE INSTALLATIONS, PATCH AND REPAIR AC PAVEMENT/SIDEWALK TO MATCH EXISTING ADJACENT SURFACES. AT NON-PAVED AREAS, RESTORE SURFACES TO MATCH EXISTING ADJACENT SURFACES.

24. ALL OUTAGES SHALL BE COORDINATED AND SCHEDULED WITH THE CONTRACTOR OFFICE AT LEAST (3) WEEKS IN ADVANCE OF REQUESTED OUTAGE IN WRITING. CONTRACTOR SHALL BE RESPONSIBLE FOR PROVIDING GENERATOR SUPPORT FOR SCHEDULED ELECTRICAL OUTAGE DUE TO CONSTRUCTION CONTRACT WORK.

25. ALL NEW PRIMARY ELECTRICAL DUCTS SHALL BE ENCASED WITH "RED" COLORED CONCRETE.

26. ALL SITE 15KV DISTRIBUTION CONDUITS SHALL INCLUDE #4/0 AWG BARE COPPER GROUND CONDUCTOR.

27. PROVIDE GROUND BOND OF SWITCHGEAR SECTIONS TO SUBSTATION GRID USING #4/0 AWG BARE COPPER WIRE AND BOLTED CONNECTIONS.

28. ALL ELECTRICAL CONDUCTORS FOR DISTRIBUTION AT 480 VOLTS AND BELOW SHALL BE THHN, 90°C INSULATION EXCEPT WHERE SPECIFIED ON SINGLE LINE DIAGRAM TO INSTALL DOL TYPE RHH/RHW-2 90°C CONDUCTORS.

29. MINIMUM CONDUCTOR SIZE SHALL BE #12 AWG FOR BOTH POWER AND CONTROL CIRCUITS.

30. OBTAIN CONFINED SPACE PERMIT FROM NASA PRIOR TO ENTRY OF UNDER GROUND MANHOLES AND VAULTS. SUBMIT A WRITTEN CONFINED SPACE SAFETY PLAN FOR REVIEW. PROVIDE PERSONNEL TRAINING CERTIFICATIONS AND MONITORING EQUIPMENT CALIBRATION TEST CERTIFICATION.

31. GOVERNMENT RESERVES THE RIGHT TO WITNESS FACTORY TESTING. NOTIFY GOVERNMENT 30 CALENDAR DAYS PRIOR TO EQUIPMENT FACTORY TESTS FOR GOVERNMENT REPRESENTATIVE ATTENDANCE.


SINGLE LINE DIAGRAM SYMBOLS

≪ - <u>52</u> -≫	15KV RATED DRAWOUT VACUUM CIRCUIT BREAKER.
	LOW VOLTAGE DRAWOUT METAL CLAD CIRCUIT BREAKER.
→	FIXED MOUNTED LOW VOLTAGE CIRCUIT BREAKER.
	DISCONNECT SWITCH, RATED AS INDICATED.
((□□→	DRAW OUT FUSE, RATED AS INDICATED.
 ○- II	SURGE ARRESTER.
- 11	GROUND CONNECTION.
why m	TRANSFORMER, RATING AS INDICATED.
METER	DIGITAL AMMETER, VOLTMETER, KILOWATT METER AS NOTED.
+	CURRENT TRANSFORMER.
~ }	DRAW OUT TYPE POTENTIAL TRANSFORMER.
PANEL	CIRCUIT BREAKER PANELBOARD, RATED PER SCHEDULE.
©	ENGINE GENERATOR, RATED AS INDICATED.
TVSS	TRANSIENT VOLTAGE SURGE SUPPRESSER.
PLC	PROGRAMMABLE LOGIC CONTROLLER.
GND BUS	GROUND BUSS, EQUIPMENT ENCLOSURE OR WALL MOUNTED.
7777	15KV, 4-WAY SWITCH.
777777	15KV, 6-WAY SWITCH.
or —	15KV CABLE SPLICE, WATER-PROOF.
· · · · · · · · · · · · · · · · · · ·	15KV FUSED LOAD BREAKER SWITCH.

TELEPHONE/DATA SYMBOLS

TELEPHONE OUTLET BOX, RECESSED WALL MOUNTED AT +48" A.F.F.

	PROVIDE SINGLE RJ45 JACK.
<u>LIGH</u>	TING SYMBOLS
	SURFACE MOUNTED LENSED FIXTURE AND JUNCTION BOX. REFER TO LIGHTING FIXTURE SCHEDULE, OR AS NOTED ON PLANS.
	SURFACE MOUNTED LENSED EMERGENCY FIXTURE AND JUNCTION BOX. REFER TO LIGHTING FIXTURE SCHEDULE, OR AS NOTED ON PLANS.
Ψ	WALL MOUNTED LIGHTING FIXTURE AND OUTLET BOX. REFER TO LIGHTING FIXTURE SCHEDULE AND PLANS FOR MOUNTING HEIGHT.
⊢⊷	STRIP LIGHTING FIXTURE AND JUNCTION BOX. REFER TO LIGHTING FIXTURE SCHEDULE, OR AS NOTED ON PLANS.
	STRIP LIGHTING EMERGENCY FIXTURE AND OUTLET BOX. REFER TO LIGHTING FIXTURE SCHEDULE, OR AS NOTED ON PLANS.
BRAN	ICH CIRCUIT SYMBOLS
A-1,3,5	HOME RUN TO PANEL. LETTER DESIGNATES PANEL, NUMBERS INDICATE CIRCUITS. UNLESS OTHERWISE NOTED.
	CONCEALED BRANCH CIRCUIT UNLESS OTHERWISE NOTED.
	CONDUIT RUN CONCEALED BELOW GRADE, 1" C MINIMUM WITH CODE SIZED EQUIPMENT GROUND.
	CONDUIT STUB OUT, CAP, MARK AND RECORD.
	CONDUIT CONTINUATION.
<u> </u>	INDICATES FLEXIBLE CONNECTION TO EQUIPMENT. NUMBER OF CONDUCTORS AS REQUIRED.
	POWER SYMBOLS
==	DUPLEX RECEPTACLE, WALL MOUNTED AT +18" A.F.F. OR AS NOTED.
= ♦	DOUBLE DUPLEX RECEPTACLE, WALL MOUNTED AT +18" A.F.F. OR AS NOTED.
-0	DUPLEX, GFCI RECEPTACLE, WALL MOUNTED AT +18" A.F.F. OR AS NOTED.
Ю	JUNCTION BOX, WALL MOUNTED AT +18" A.F.F. OR AS NOTED. 4S/DP MINIMUM OR AS REQUIRED BY N.E.C
0	JUNCTION BOX, MOUNTED IN ACCESSIBLE CEILING FOR APPLICATION DENOTED ON PLAN. 4S/DP MINIMUM OR AS REQUIRED BY N.E.C
Ø	EXHAUST FAN, OR MOTOR LOAD. REFER TO MECHANICAL, PLUMBING OR KITCHEN DRAWINGS FOR SPECIFIC LOAD REQUIREMENTS OR AS NOTED.
	FLUSH MOUNTED ELECTRICAL PANELBOARD OR LOAD CENTER. REFER TO PANEL SCHEDULE.
	SURFACE MOUNTED ELECTRICAL PANELBOARD OR LOAD CENTER. REFER TO PANEL SCHEDULE.
T	TRANSFORMER, REFER TO SINGLE LINE DIAGRAM.
E	FUSED DISCONNECT SWITCH, HP RATED WITH FUSES PER EQUIPMENT MANUFACTURER AND WEATHERPROOF AS REQUIRED. PROVIDE FINAL CONNECTION TO UNIT EQUIPMENT.
□	NON-FUSED DISCONNECT SWITCH, HP RATED AND WEATHERPROOF AS REQUIRED. PROVIDE FINAL CONNECTION TO UNIT EQUIPMENT
 	GROUND CONNECTION, SIZE AS INDICATED OR AS REQUIRED.
\$a,b	SINGLE POLE SWITCHES, WALL MOUNTED AT +48" A.F.F. (MAX). SUBSCRIPTS AT SYMBOL INDICATE THE FOLLOWING: 2 — DOUBLE POLE 3 — THREE WAY 4 — FOUR WAY K — KEY OPERATED LV — LOW VOLTAGE AT +48" A.F.F. (MAX). SUBSCRIPTS AT SYMBOL P. P. PILOT LIGHT R — REMOTE CONTROL M — MOTOR STARTING RL — ROTARY LOCK KEY TYPE PB — PUSHBUTTON

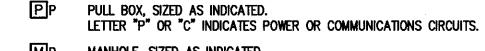


ENGRAVED WITH "EMERGENCY"


a, b, c, etc. - Designates quantity of switches at each location.

NOTE: ALL WALL SWITCHES CONTROLLING EMERGENCY CIRCUITS SHALL BE

MANHOLE, SIZED AS INDICATED. LETTER "P" OR "C" INDICATES POWER OR COMMNICATIONS CIRCUITS.

GROUND WELL

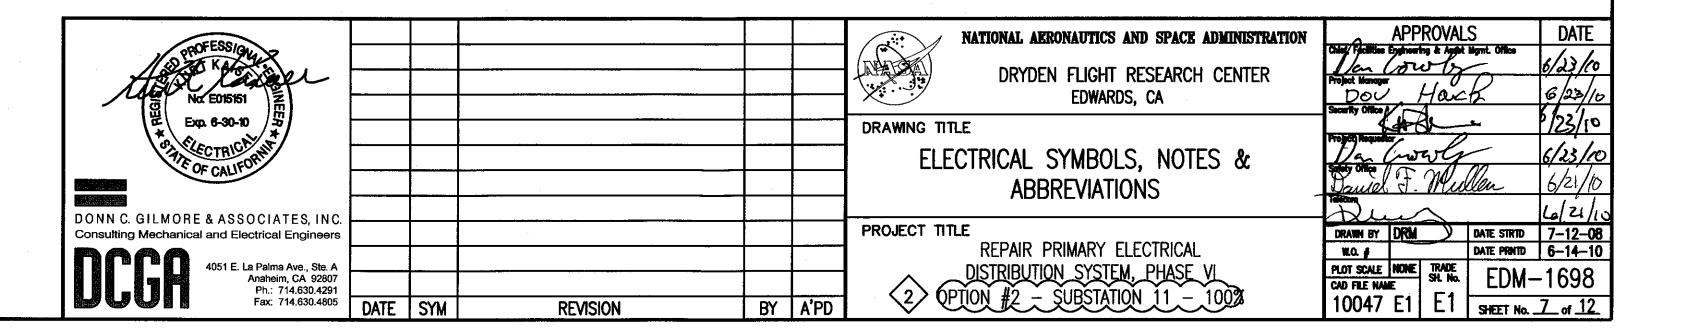

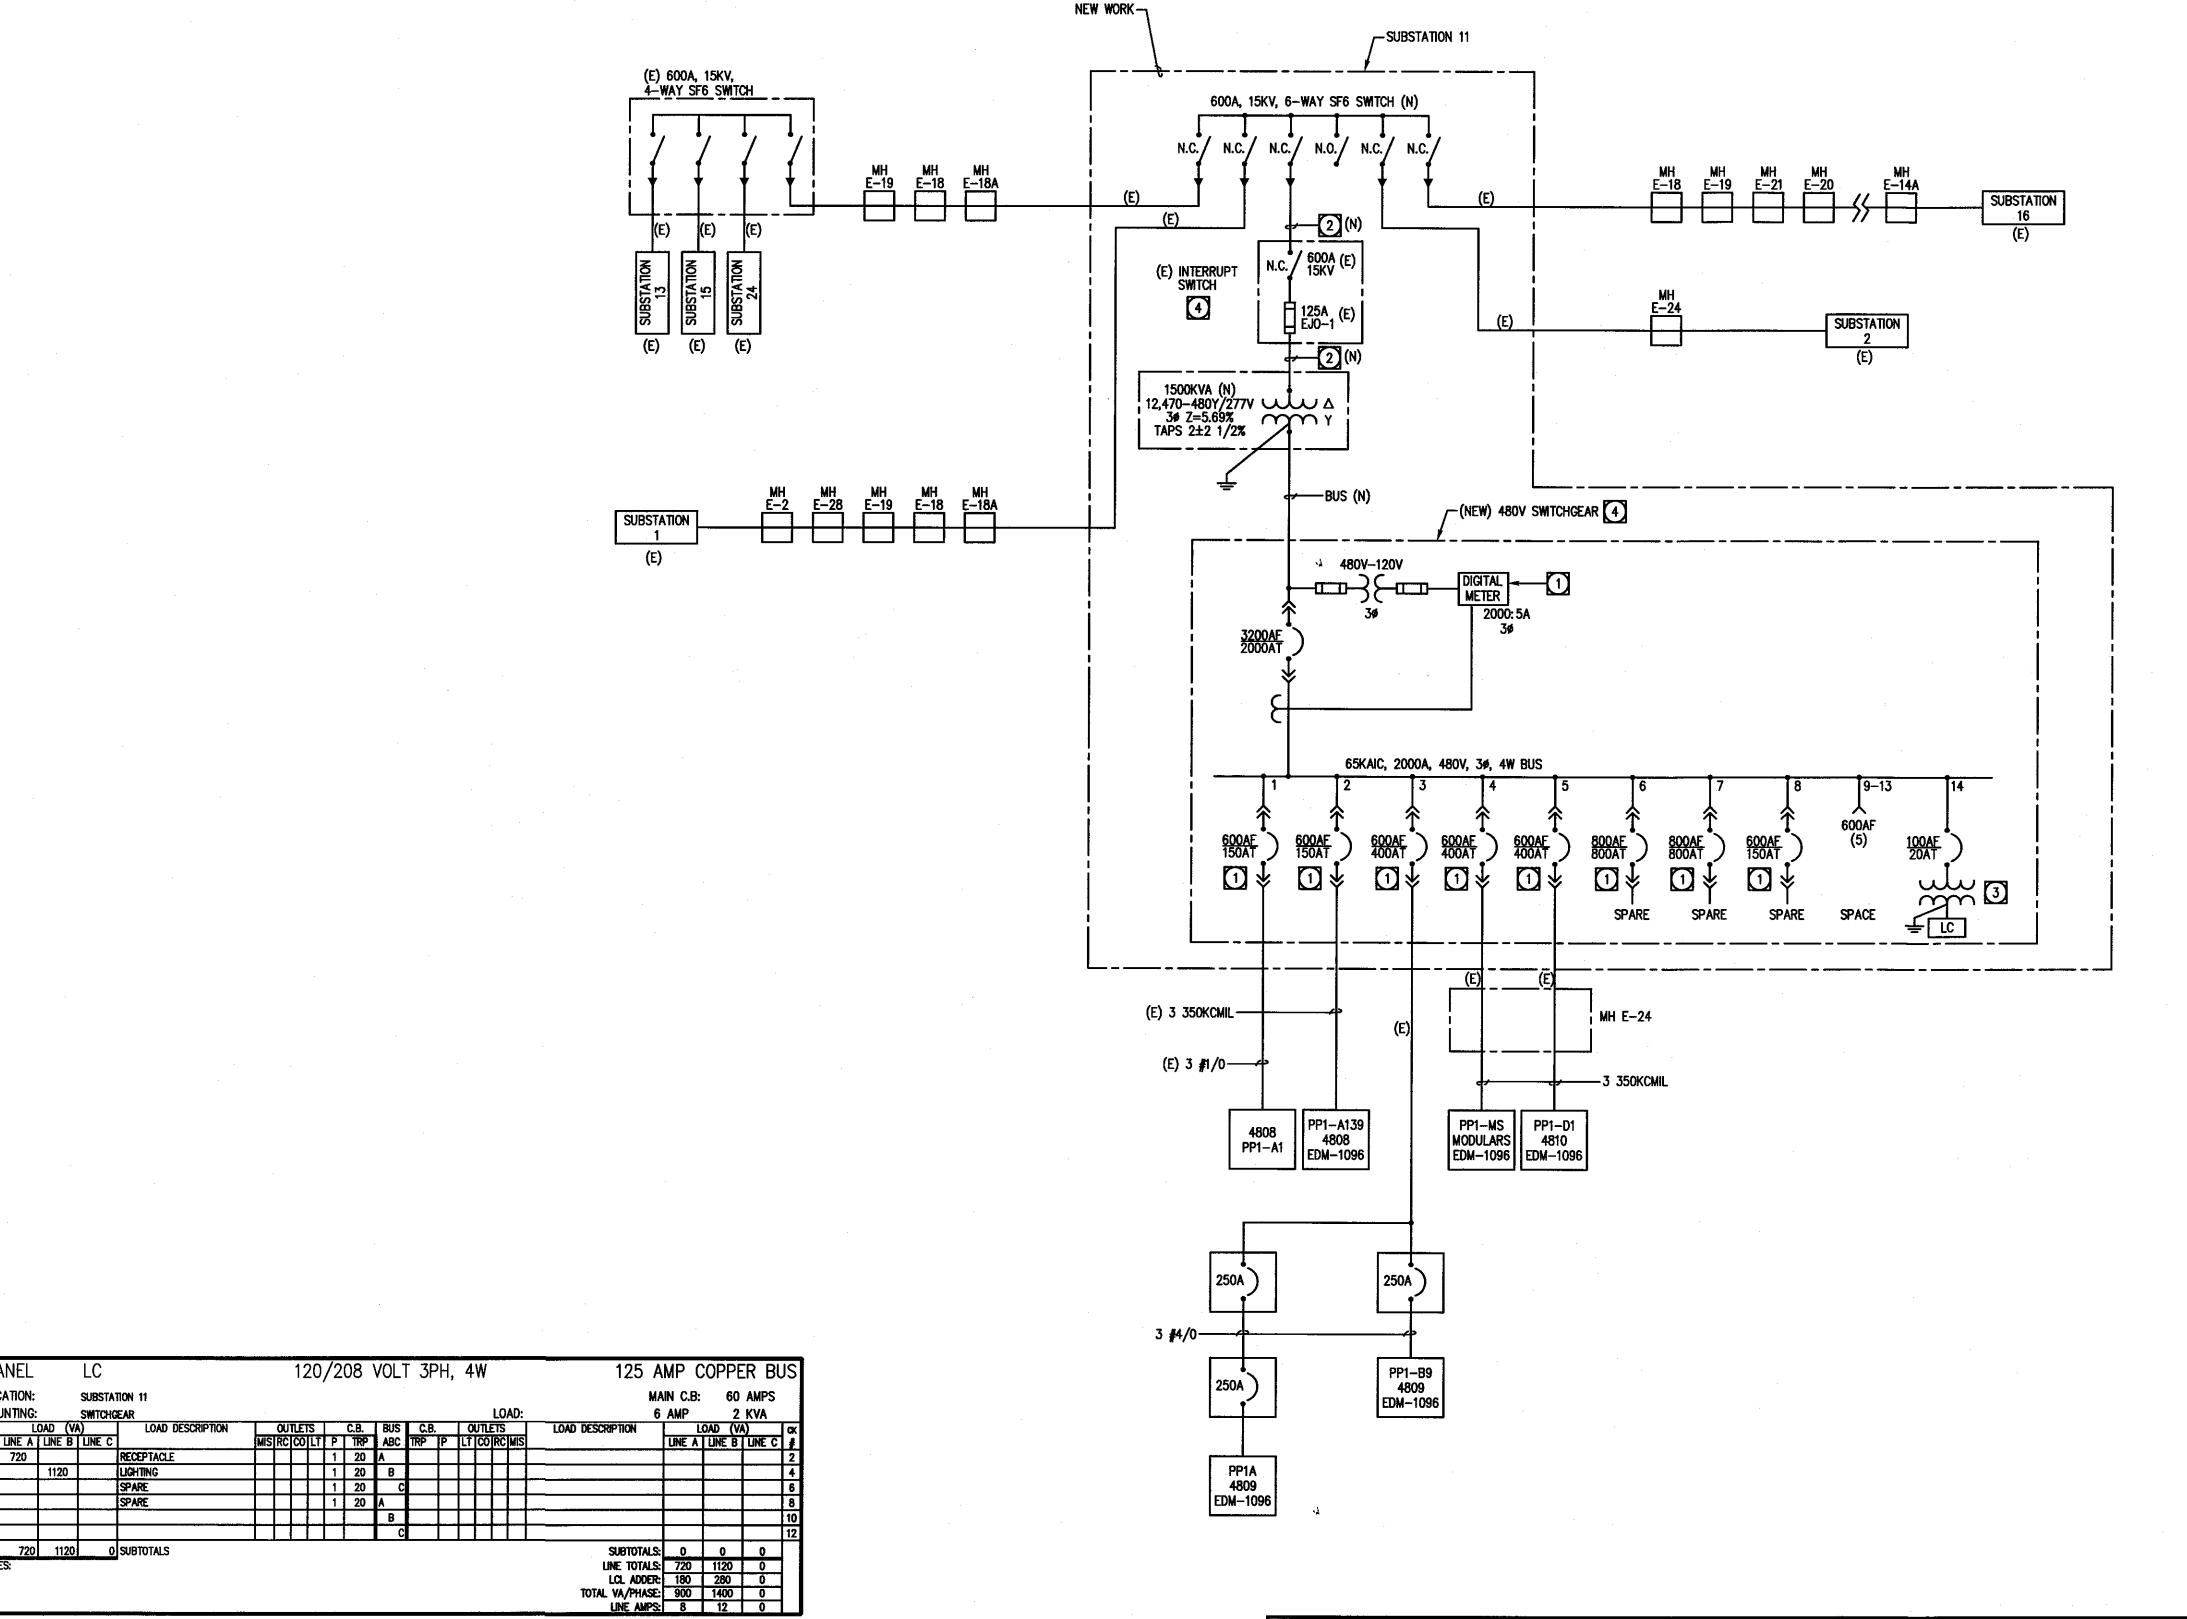

SINGLE LINE DIAGRAM NOTES:

PROVIDE SQUARE D POWER LOGIC SERIES 4000 CIRCUIT MONITOR MODEL CM4250, WITH MODEL CMDVF VACUUM FLUORESCENT DISPLAY AND MODEL ECC21 ETHERNET COMMUNICATIONS CARD. PROVIDE MONITOR FOR ALL FEEDER CIRCUIT BREAKERS AND MAIN BREAKER.

PROVIDE 3 #350KCMIL, 15KV, 133% INSULATION & 1 #4/0 BARE COPPER CROUND WIRE.

PROVIDE 15KVA, 480V-120/208V, 3-PHASE, 4-WIRE TRANSFORMER AND 100A, 120/208V, 3-PHASE, 4-WIRE LOAD CENTER INTEGRATED IN SWITCHGEAR ENCLOSURE. SEE LOAD CENTER "LC" SCHEDULE, THIS SHEET.

PROVIDE FAULT CURRENT ANALYSIS, COORDINATION STUDY, AND ARC FLASH HAZARD ANALYSIS. PROVIDE ARC FLASH LABELS ON 15KV INTERRUPTER SWITCH ENCLOSURE AND EACH 480V CIRCUIT BREAKER CUBICLE FRONT PANEL, PER NASA GUIDELINES. INSTALL 480V CIRCUIT BREAKER LSIG SETTINGS PER COORDINATION STUDY RESULTS.

APPROVALS
Chief Facilities Engineering & Asset/Alignet. 0
Project Manager


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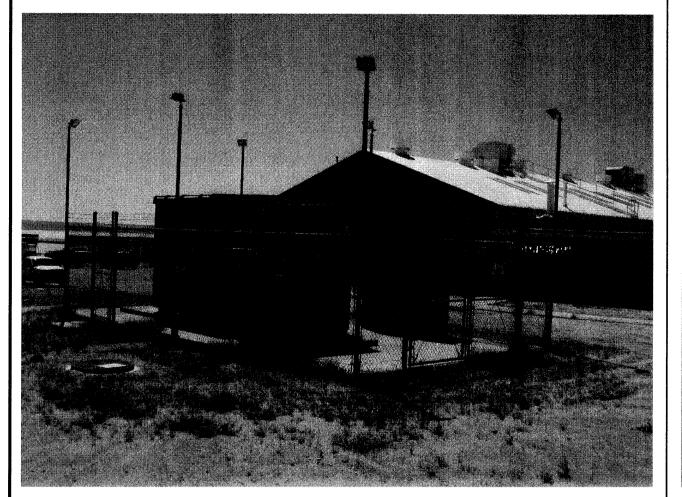
Security Office


Project Respector. NATIONAL AERONAUTICS AND SPACE ADMINISTRATION DRYDEN FLIGHT RESEARCH CENTER EDWARDS, CA DRAWING TITLE SINGLE LINE DIAGRAM DONN C. GILMORE & ASSOCIATES, INC. DRAWN BY DRAW DATE STRTD 7-12-08
W.O. # DATE PRINTD 6-14-10
PLOT SCALE NOME TRADE SH. No. EDM-1698
10047 E2 E2 SHEET No. 8 of 12 PROJECT TITLE Consulting Mechanical and Electrical Engineers REPAIR PRIMARY ELECTRICAL
DISTRIBUTION SYSTEM, PHASE VI

2 OPTION #2 - SUBSTATION 11 - 1003 4051 E. La Palma Ave., Ste. A Anaheim, CA 92807 Ph.: 714.630.4291 BY A'PD Fax: 714.630.4805 DATE SYM REVISION

LOCATION:



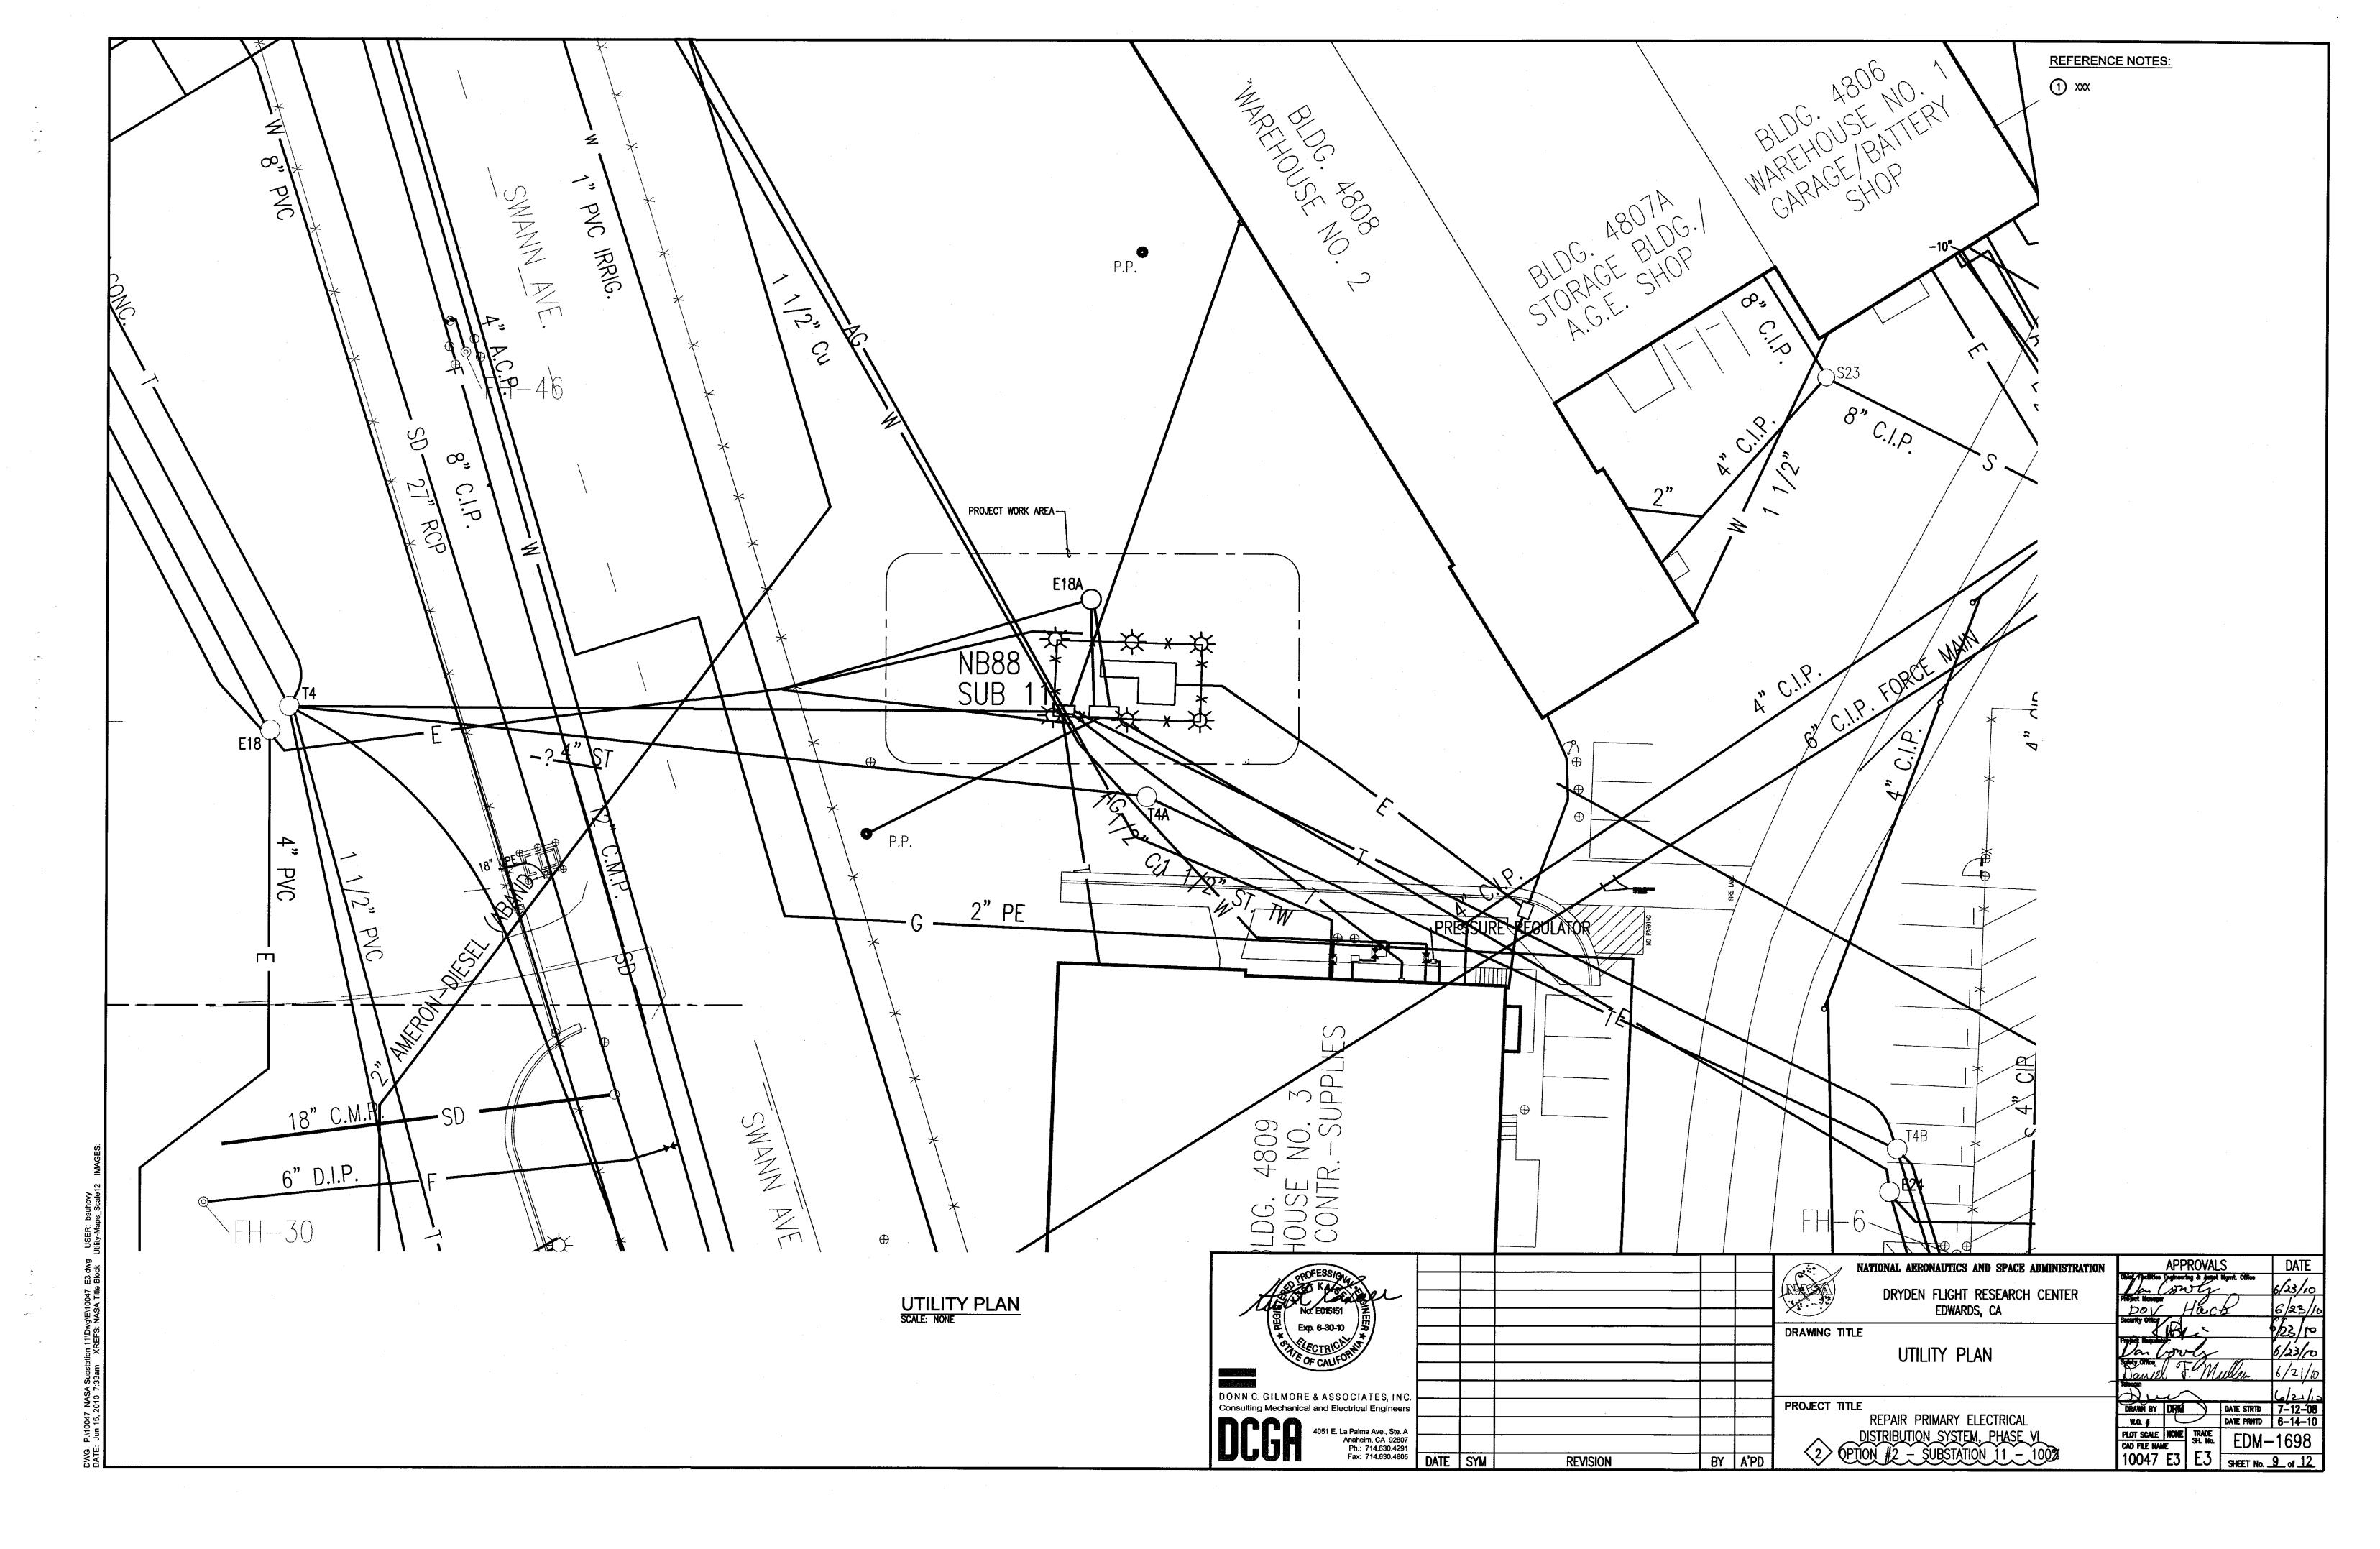

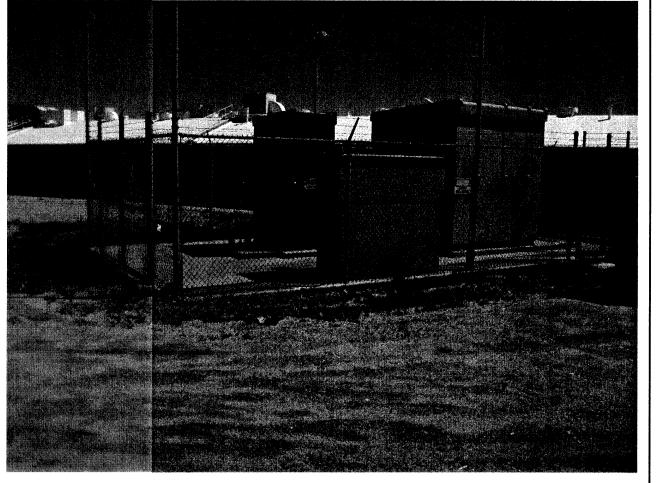


SUBSTATION 11 NORTHWEST FACE SCALE: NTS 1 E4 E4


SUBSTATION 11 SOUTHWEST FACE

SCALE: 2


NTS E4 E4



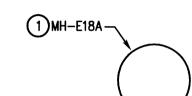

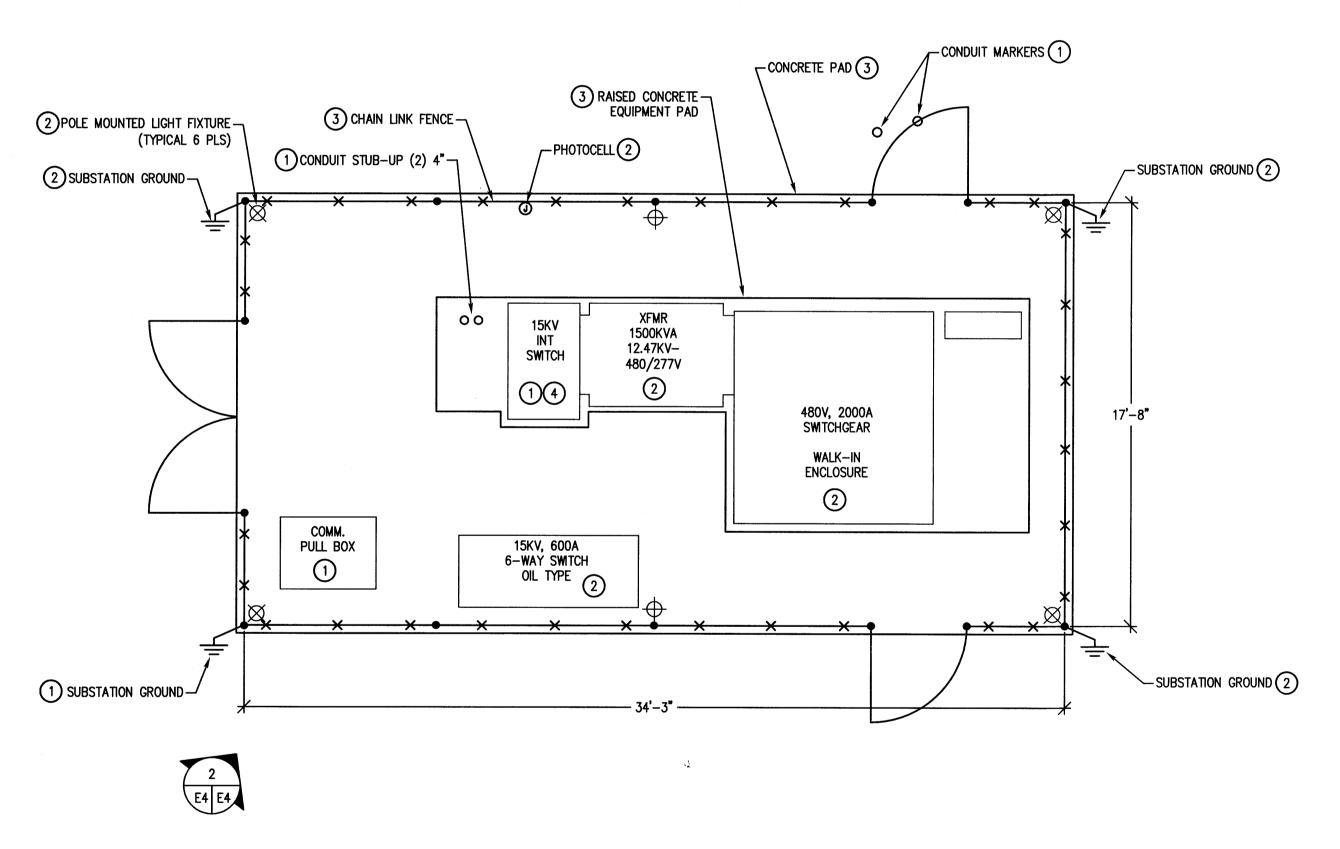

PARTIAL SITE PLAN - DEMOLITION SCALE: 1/4"=1'-0"

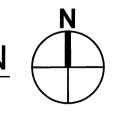

25520						NATIONAL AERONAUTICS AND SPACE ADMINISTRATION	APPROVALS	DATE
W ZA KAONA						NATA DECEMBER OF MEDIA	Chief, Facilities Engineering & Asset Mgmt. Office	6/23/10
HOST CARRELL						DRYDEN FLIGHT RESEARCH CENTER	Project Manager	
No. E015151 Z						EDWARDS, CA	Security Office	6/23/10
Exp. 6-30-10 /= / *						DRAWNG TITLE	& the Comment	1/8/jo
(2, (2),,,,,,,, .						PARTIAL SITE PLAN	Project Requestor	6/23/10
FOF CALIFORNIA							Safety Office	1/21/0
						DEMOLITION	Telecom 5	0/2/10
DONN C. GILMORE & ASSOCIATES, INC.				-		DDO ICOT TITIC		6/24/10
Consulting Mechanical and Electrical Engineers						PROJECT TITLE REPAIR PRIMARY ELECTRICAL	DRAWN BY DRM DATE STRID W.O. 4 DATE PRINTD	7-12-08 6-14-10
4051 E. La Palma Ave., Ste. A						DISTRIBUTION SYSTEM, PHASE VI		
Anaheim, CA 92807 Ph.: 714.630.4291							CAD FILE NAME	-1698
Fax: 714.630.4805	DATE	SYM	REVISION	BY	A'PD	2> OPTION #2 - SUBSTATION 11 - 100%	10047 E4 E4 SHEET No	10 of 12

PLAN SPECIFIC NOTES:


1 EXISTING EQUIPMENT TO REMAIN

2 EQUIPMENT TO BE DE-ENERGISED, DISCONNECTED, AND REMOVED. DISPOSE OF PER CONTRACTING OFFICER DIRECTION.

DISCONNECT AND REMOVE THIS EQUIPMENT TO ALLOW WORKING CLEARANCE FOR OTHER TRADES. STORE ON SITE FOR RE-INSTALLATION PER REMODEL PLAN.


3 EQUIPMENT TO BE DEMOLISHED OR REMODELED PER CIVIL PLANS. DISCONNECT AND REMOVE ELECTRICAL GROUND WIRES AND LIGHT FIXTURES.

110047 NASA Substation 11\Dwg\E\10047 E4.dwg USER: bsuhovy

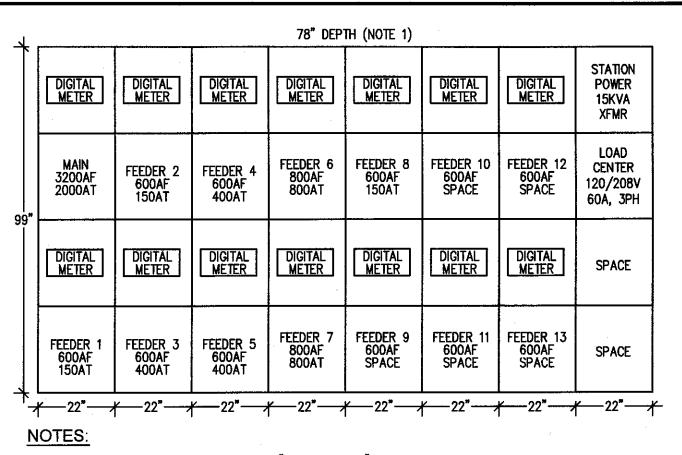

1. PROVIDE WALK-IN ENCLOSURE WITH "TOP-OF-GEAR" BREAKER LIFTER AND FRONT ACCESS DOORS.


> 480V SWITCHGEAR FRONT ELEVATION E5 E5

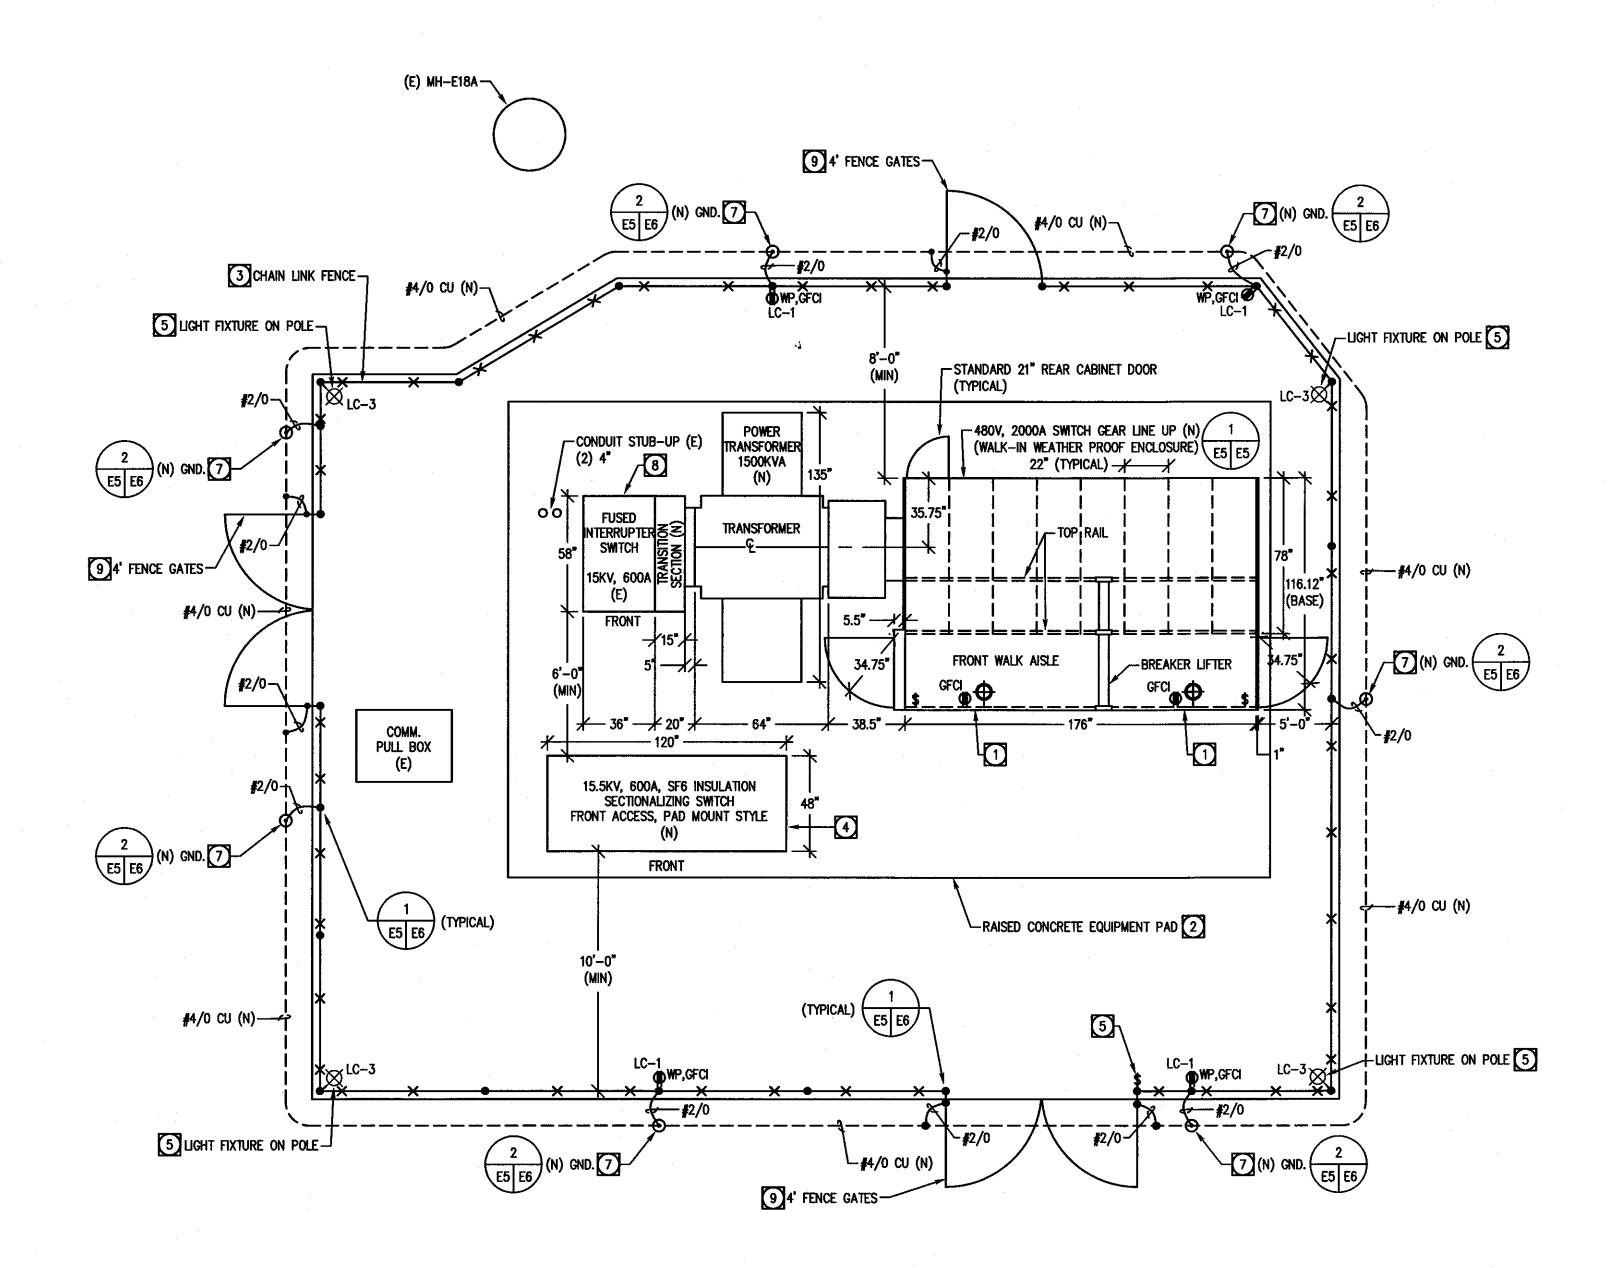

PLAN SPECIFIC NOTES:

- PROVIDE PREWIRED INTERIOR LIGHTING (SWITCHED) AND MAINTENANCE RECEPTACLES.
- RAISED CONCRETE EQUIPMENT PAD AND SLAB ON GRADE TO BE PROVIDED PER CIVIL PLANS.
- CHAIN LINK FENCE TO BE PROVIDED WITH CLEARANCES SHOWN, PER CIVIL PLANS.
- PROVIDE SPECIFIED SF6 SWITCH INSTALLED OVER EXISTING 15KV FEEDER CONDUIT STUB-UPS. RECONNECT EXISTING FEEDERS PER SINGLE LINE DIAGRAM.
- PROVIDE 250W METAL HALIDE FIXTURE, WITH DARK BRONZE COLOR AND MULTI-TAP BALLAST (SPAULDING LIGHTING MODEL NO. ASB-C-250MH-DB-MT OR EQUIVALENT), TENON TOP POLE MOUNTED ON 15 FOOT ROUND 4" STEEL POLE, USED AS FENCE CORNER POST, WITH CONCRETE BASE. PROVIDE PHOTOCELL CONTROL (FOR AUTO OFF) ON LIGHT FIXTURE CIRCUIT, WITH POLE MOUNTED, NORTH FACING UNIT. MOUNT FIXTURE AT +12' ABOVE FINISHED SLAB ON GRADE. PROVIDE TOGGLE SWITCH, IN A WEATHER-PROOF ENCLOSURE FOR MANUAL ON/OFF CONTROL.
- EXPAND EXISTING CONCRETE SLAB AS SHOWN TO ALLOW FENCE INSTALLATION AT SPECIFIED CODE REQUIRED MAINTENANCE CLEARANCE FROM THE ELECTRICAL EQUIPMENT.
- PROVIDE GROUND WELL WITH 10'x3/4" DIA COPPER-CLAD STEEL ROD. PROVIDE CONNECTING GROUND WIRE (#4/0 CU), TO ALL GROUND RODS, AT 12" BELOW GRADE. BOND ALL NEW AND EXISTING POWER EQUIPMENT AND FENCING TO GROUND SYSTEM WITH #2/0 COPPER CONDUCTORS.
- REINSTALL EXISTING FUSED INTERRUPTER SWITCH OVER EXISTING 15KV FEEDER CONDUIT STUB-UPS. RECONNECT EXISTING FEEDERS PER SINGLE LINE DIAGRAM.
- PROVIDE PERMANENT "WARNING-HIGH VOLTAGE" SIGNAGE, PER ANSI X535 STANDARD, ON SUBSTATION GATES.

PARTIAL SITE PLAN - REMODEL

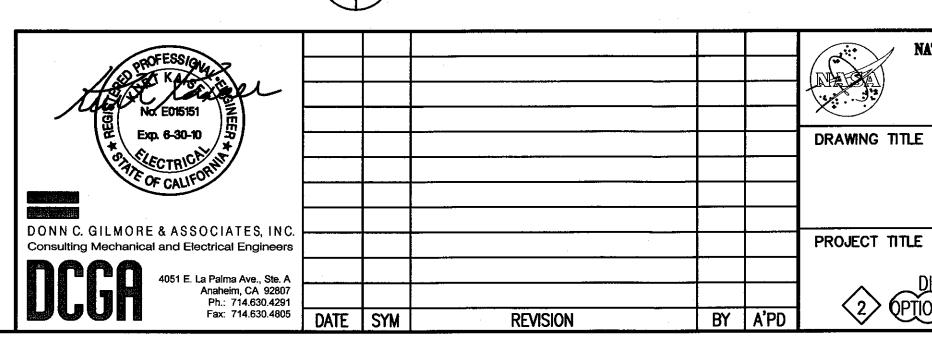



NATIONAL AERONAUTICS AND SPACE ADMINISTRATION DRYDEN FLIGHT RESEARCH CENTER EDWARDS, CA


PARTIAL SITE PLAN REMODEL

REPAIR PRIMARY ELECTRICAL

PLOT SCALE | NONE | TRADE | SH. No. | EDM - 1698 | 10047 | E5 | E5 | SHEET No. 11 of 12

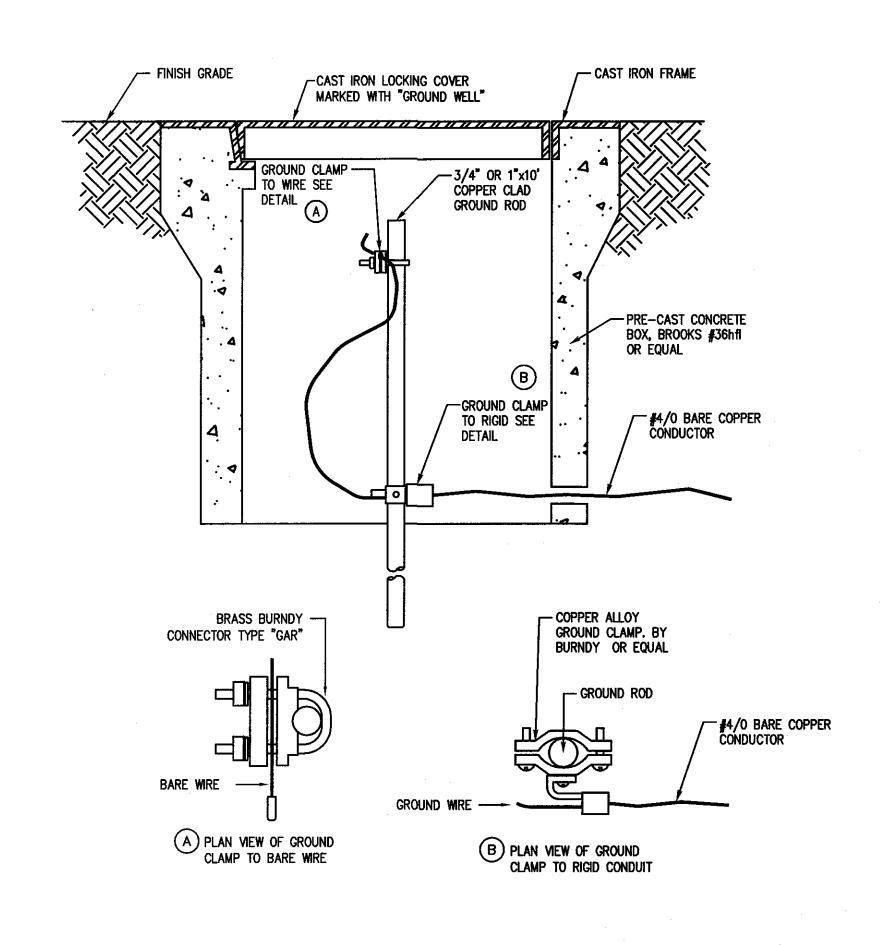

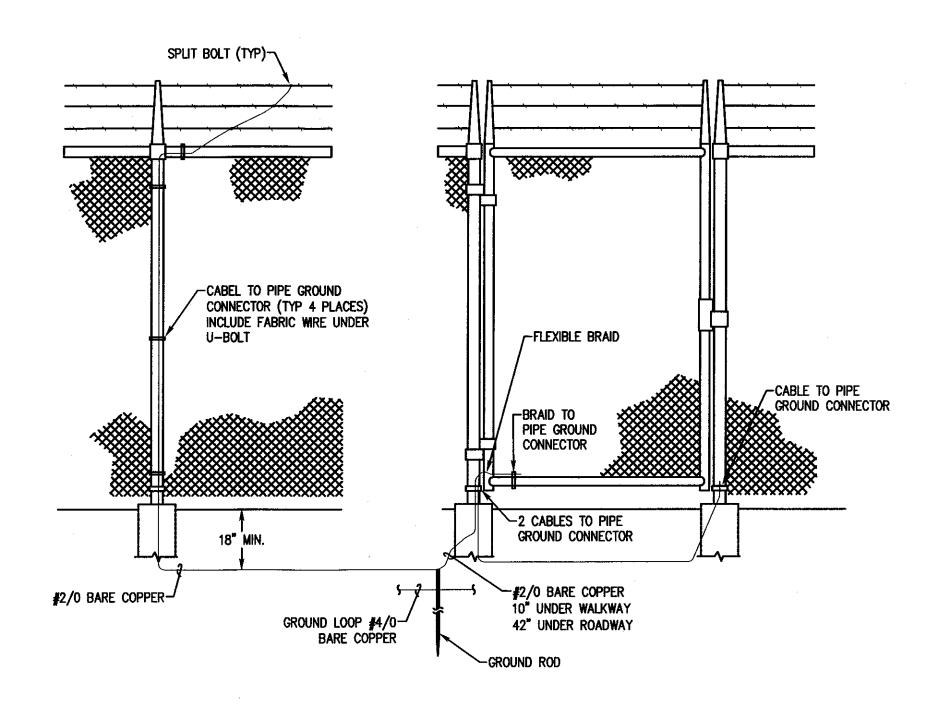

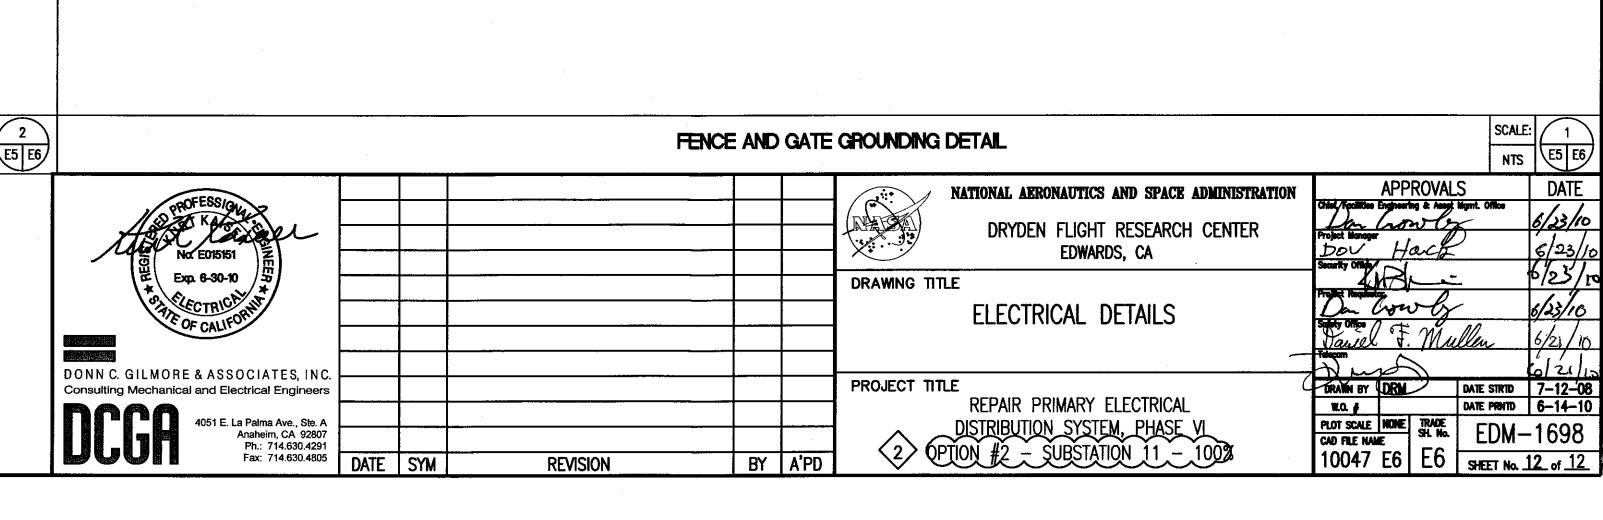

GROUND WELL DETAIL

SCALE: 2

NTS

2

E5 E6

VG: P:\10047 NASA Substation 11\Dwa\E\10047 E6.dwa